$\underline{Schedule~B4}$ Jericho Transmission Pole Clear Zone Mitigation Map



Civil\current\JTLsite G&G.dwg

EXISTING SERVICES

JTLsite G&G.dwg







- 2											
awings	EXISTING SERVICES	DRAWING #, SOURCE	DATE	AS CONSTRUCTED SERVICES	COMPLETION	DETAILS	No.	REVISIONS	DATE	CONSULTANT	co
å						DESIGN RWC	1	ISSUED FOR LEAVE TO CONSTRUCT	2013-10-07		
5.9						DRAWN BY MWB	2	ISSUED FOR LTC AMMENDMENT	2013-11-20		
180						CHECKED RWC					
Ē						APPROVED RWC					
0						DATE 2013-08-29					1
함											
ř											
38											1
346						JTLsite G&G.dwo					
3						UILSILE G&G.UW					

BIGROUP


IBI Group 203 - 350 Oxford Street West London ON N6H 1T3 Canada

tel 519 472 7328 fax 519 472 9354 NEXT ERA ENERGY



JERICHO WIND ENERGY CENTRE
MUNICIPALITY OF N. MIDDLESEX AND LAMBTON COUNTY
SHEET NO.

JTLSITE G&G - 1 j-n003 to j-n017 CZS—1

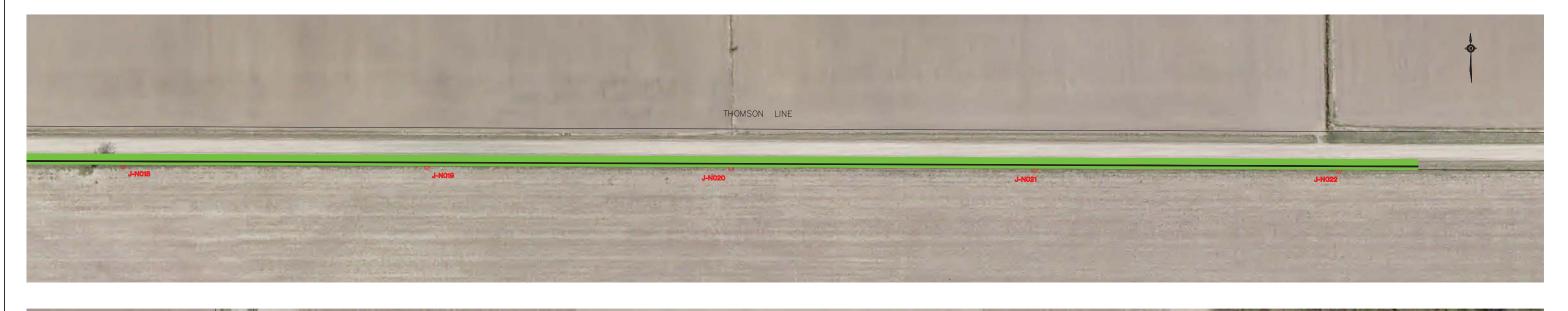





-											
awings	EXISTING SERVICES	DRAWING #, SOURCE	DATE	AS CONSTRUCTED SERVICES	COMPLETION	DETAILS	No.	REVISIONS	DATE	CONSULTANT	C
å						DESIGN RWC	1	ISSUED FOR LEAVE TO CONSTRUCT	2013-10-07		i
5.9						DRAWN BY MWB	2	ISSUED FOR LTC AMMENDMENT	2013-11-20		i i
180						CHECKED RWC					i
Ē						APPROVED RWC					i
0						DATE 2013-08-29					i i
함											i
ř											i i
338											i
346						JTLsite G&G.dwd					i
- 5						OTESILE GCG.GWG					i



IBI Group 203 - 350 Oxford Street West London ON N6H 1T3 Canada

tel 519 472 7328 fax 519 472 9354 NEXT ERA ENERGY

1: 1000	ľ
1 <u>0 0 20</u> m	ı

JERICHO	WIND	ENE	RGY	CENTRE	Ξ	
INICIPALITY OF N	I. MIDDL	ESEX	AND	LAMBTON	COUNTY	

JTLSITE G&G — 2 j-n018 to j-n033 CZS-2







~											
awings	EXISTING SERVICES	DRAWING #, SOURCE	DATE	AS CONSTRUCTED SERVICES	COMPLETION	DETAILS	No.	REVISIONS	DATE	CONSULTANT	CO
å						DESIGN RWC	1	ISSUED FOR LEAVE TO CONSTRUCT	2013-10-07		
6.0						DRAWN BY MWB	2	ISSUED FOR LTC AMMENDMENT	2013-11-20		1
13						CHECKED RWC					ı
Ē						APPROVED RWC					ı
0						DATE 2013-08-29					ı
흔											ı
?											ı
89											ı
349						JTLsite G&G.dwo					
3						JILSILE G&G.GWQ					

IBI

IBI Group 203 - 350 Oxford Street West London ON N6H 1T3 Canada

> tel 519 472 7328 fax 519 472 9354

NEXT ERA ENERGY

1:1000		
10 0	20m	١
		Γ

JERICHO WIND ENERGY CENTRE

MUNICIPALITY OF N. MIDDLESEX AND LAMBTON COUNTY

SHEET No.

JTLSITE G&G - 3 J-N034 TO J-N049 CZS-3











ò											
awings	EXISTING SERVICES	DRAWING #, SOURCE	DATE	AS CONSTRUCTED SERVICES	COMPLETION	DETAILS	No.	REVISIONS	DATE	CONSULTANT	CON
ă						DESIGN RWC	-1	ISSUE FOR LEAVE TO CONSTRUCT	2013-10-07		ĺ
60						DRAWN BY MWB					
18						CHECKED RWC					1
흔						APPROVED RWC					
6						DATE 2013-08-29					ı
i											
7											i
38											1
345						JTLsite G&G.dwd					1
- E						UILSILE Gac.uwg					1

IBI

IBI Group 203 - 350 Oxford Street West London ON N6H 1T3 Canada


tel 519 472 7328 fax 519 472 9354 NEXT ERA ENERGY

1:1000	l
1 <u>0 0 20</u> m	ı
	Γ


JERICHO WIND ENERGY CENTRE
MUNICIPALITY OF N. MIDDLESEX AND LAMBTON COUNTY
SHEET No.

JTLSITE G&G - 4 J-N050 TO J-N067 CZS-4


PLAN FILE No.

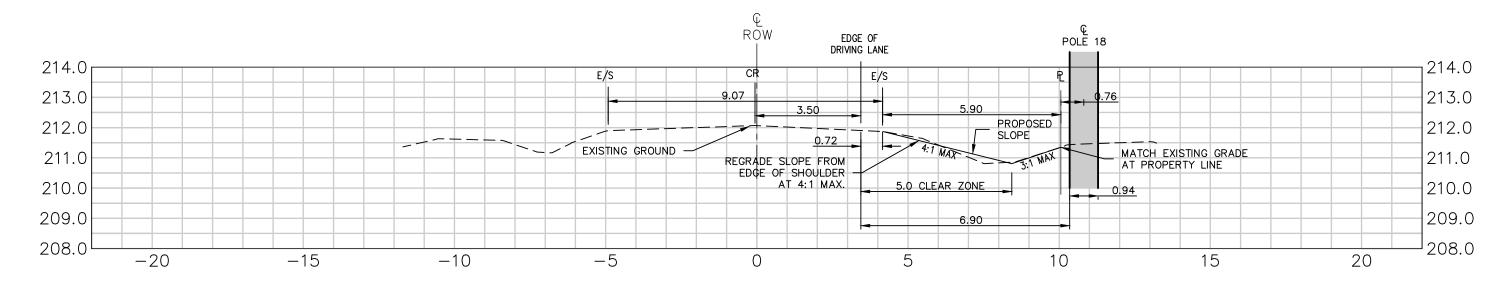


J-N018 - 4+288.7 Thomson Line

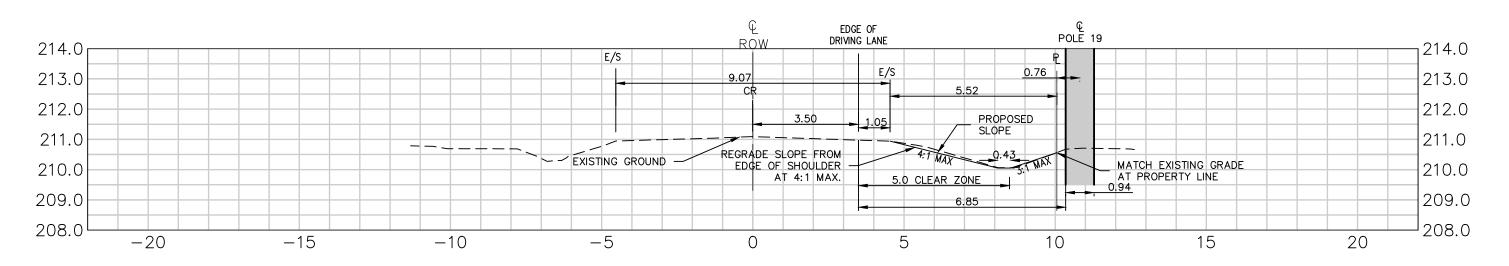


J-N019 - 4+449.5 Thomson Line

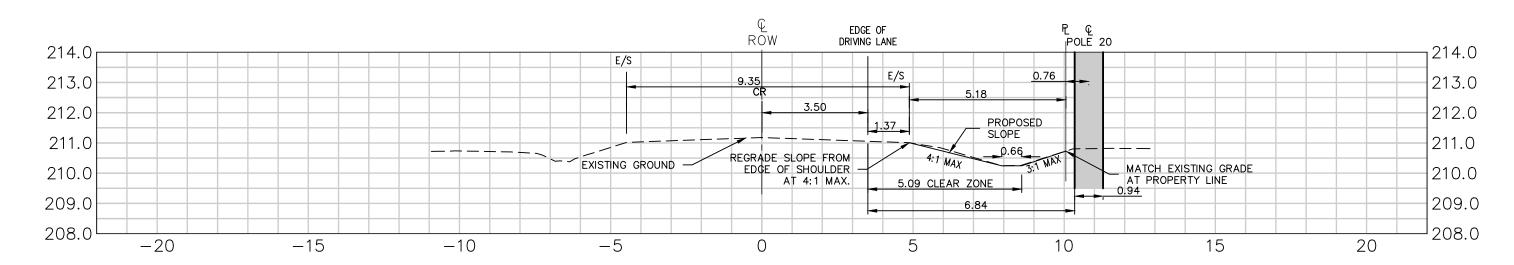

J-N020 - 4+610.3 Thomson Line

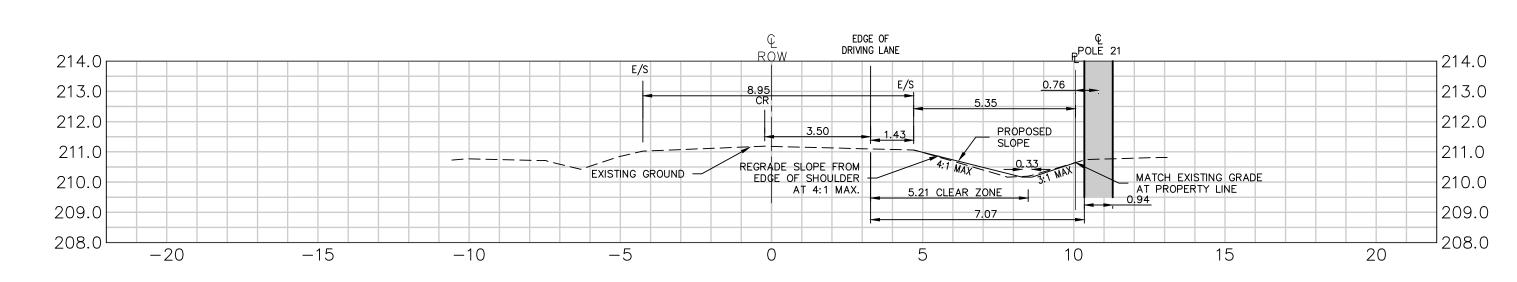

J-N021 - 4+771.1 Thomson Line

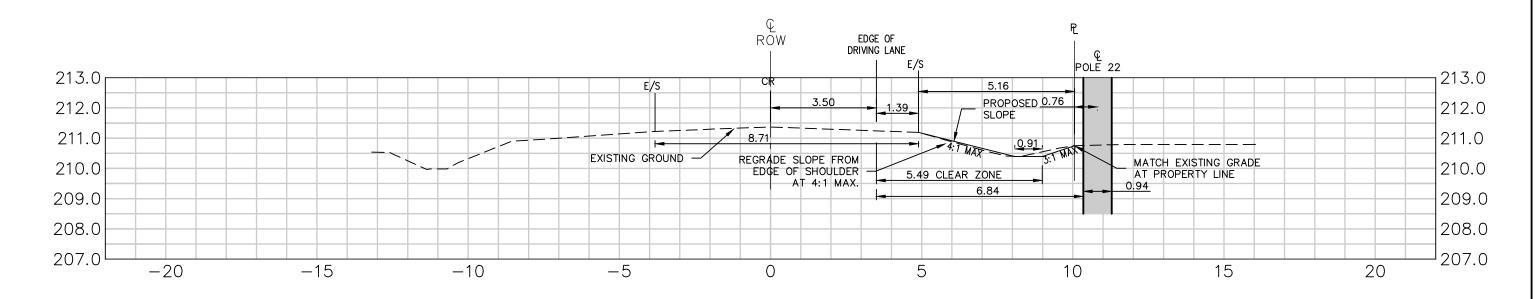

J-N022 - 4+931.9 Thomson Line

awings	EXISTING SERVICES	DRAWING #, SOURCE	DATE	AS CONSTRUCTED SERVICES	COMPLETION	DETAILS	No.	REVISIONS	DATE	CONSULTANT	CONSU
۵						DESIGN	1	ISSUED FOR LTC AMMENDMENT	2013-11-20		
5.9						DRAWN BY BDH					
\su						CHECKED RWC					
Tra						APPROVED RWC					
-01						DATE 2013-11-20					
rich											
ا ا											
338											
346						CS-01.DWG					
<u> </u>	·					U3-U1.DWG					1




IBI Group 203 - 350 Oxford Street West London ON N6H 1T3 Canada
tel 519 472 7328 fax 519 472 9354

N6H 1T3 Canada	NEXT ERA ENERGY
7328	

ENGINEER'S STAMP

ALE			Т
HORZ 1	:150		
VERT 1	: 150		
1,5	Q	3m	
	HORIZONTAL		
1,5	Q	3m	
	VERTICAL		

'LE	PROJECT No.
JERICHO WIND ENERGY CENTRE	34938
MUNICIPALITY OF N. MIDDLESEX AND LAMBTON COUNTY	SHEET No.
JTL MITIGATION - P18 TO P22	CS-0
DITCH CROSS SECTIONS	PLAN FILE No.

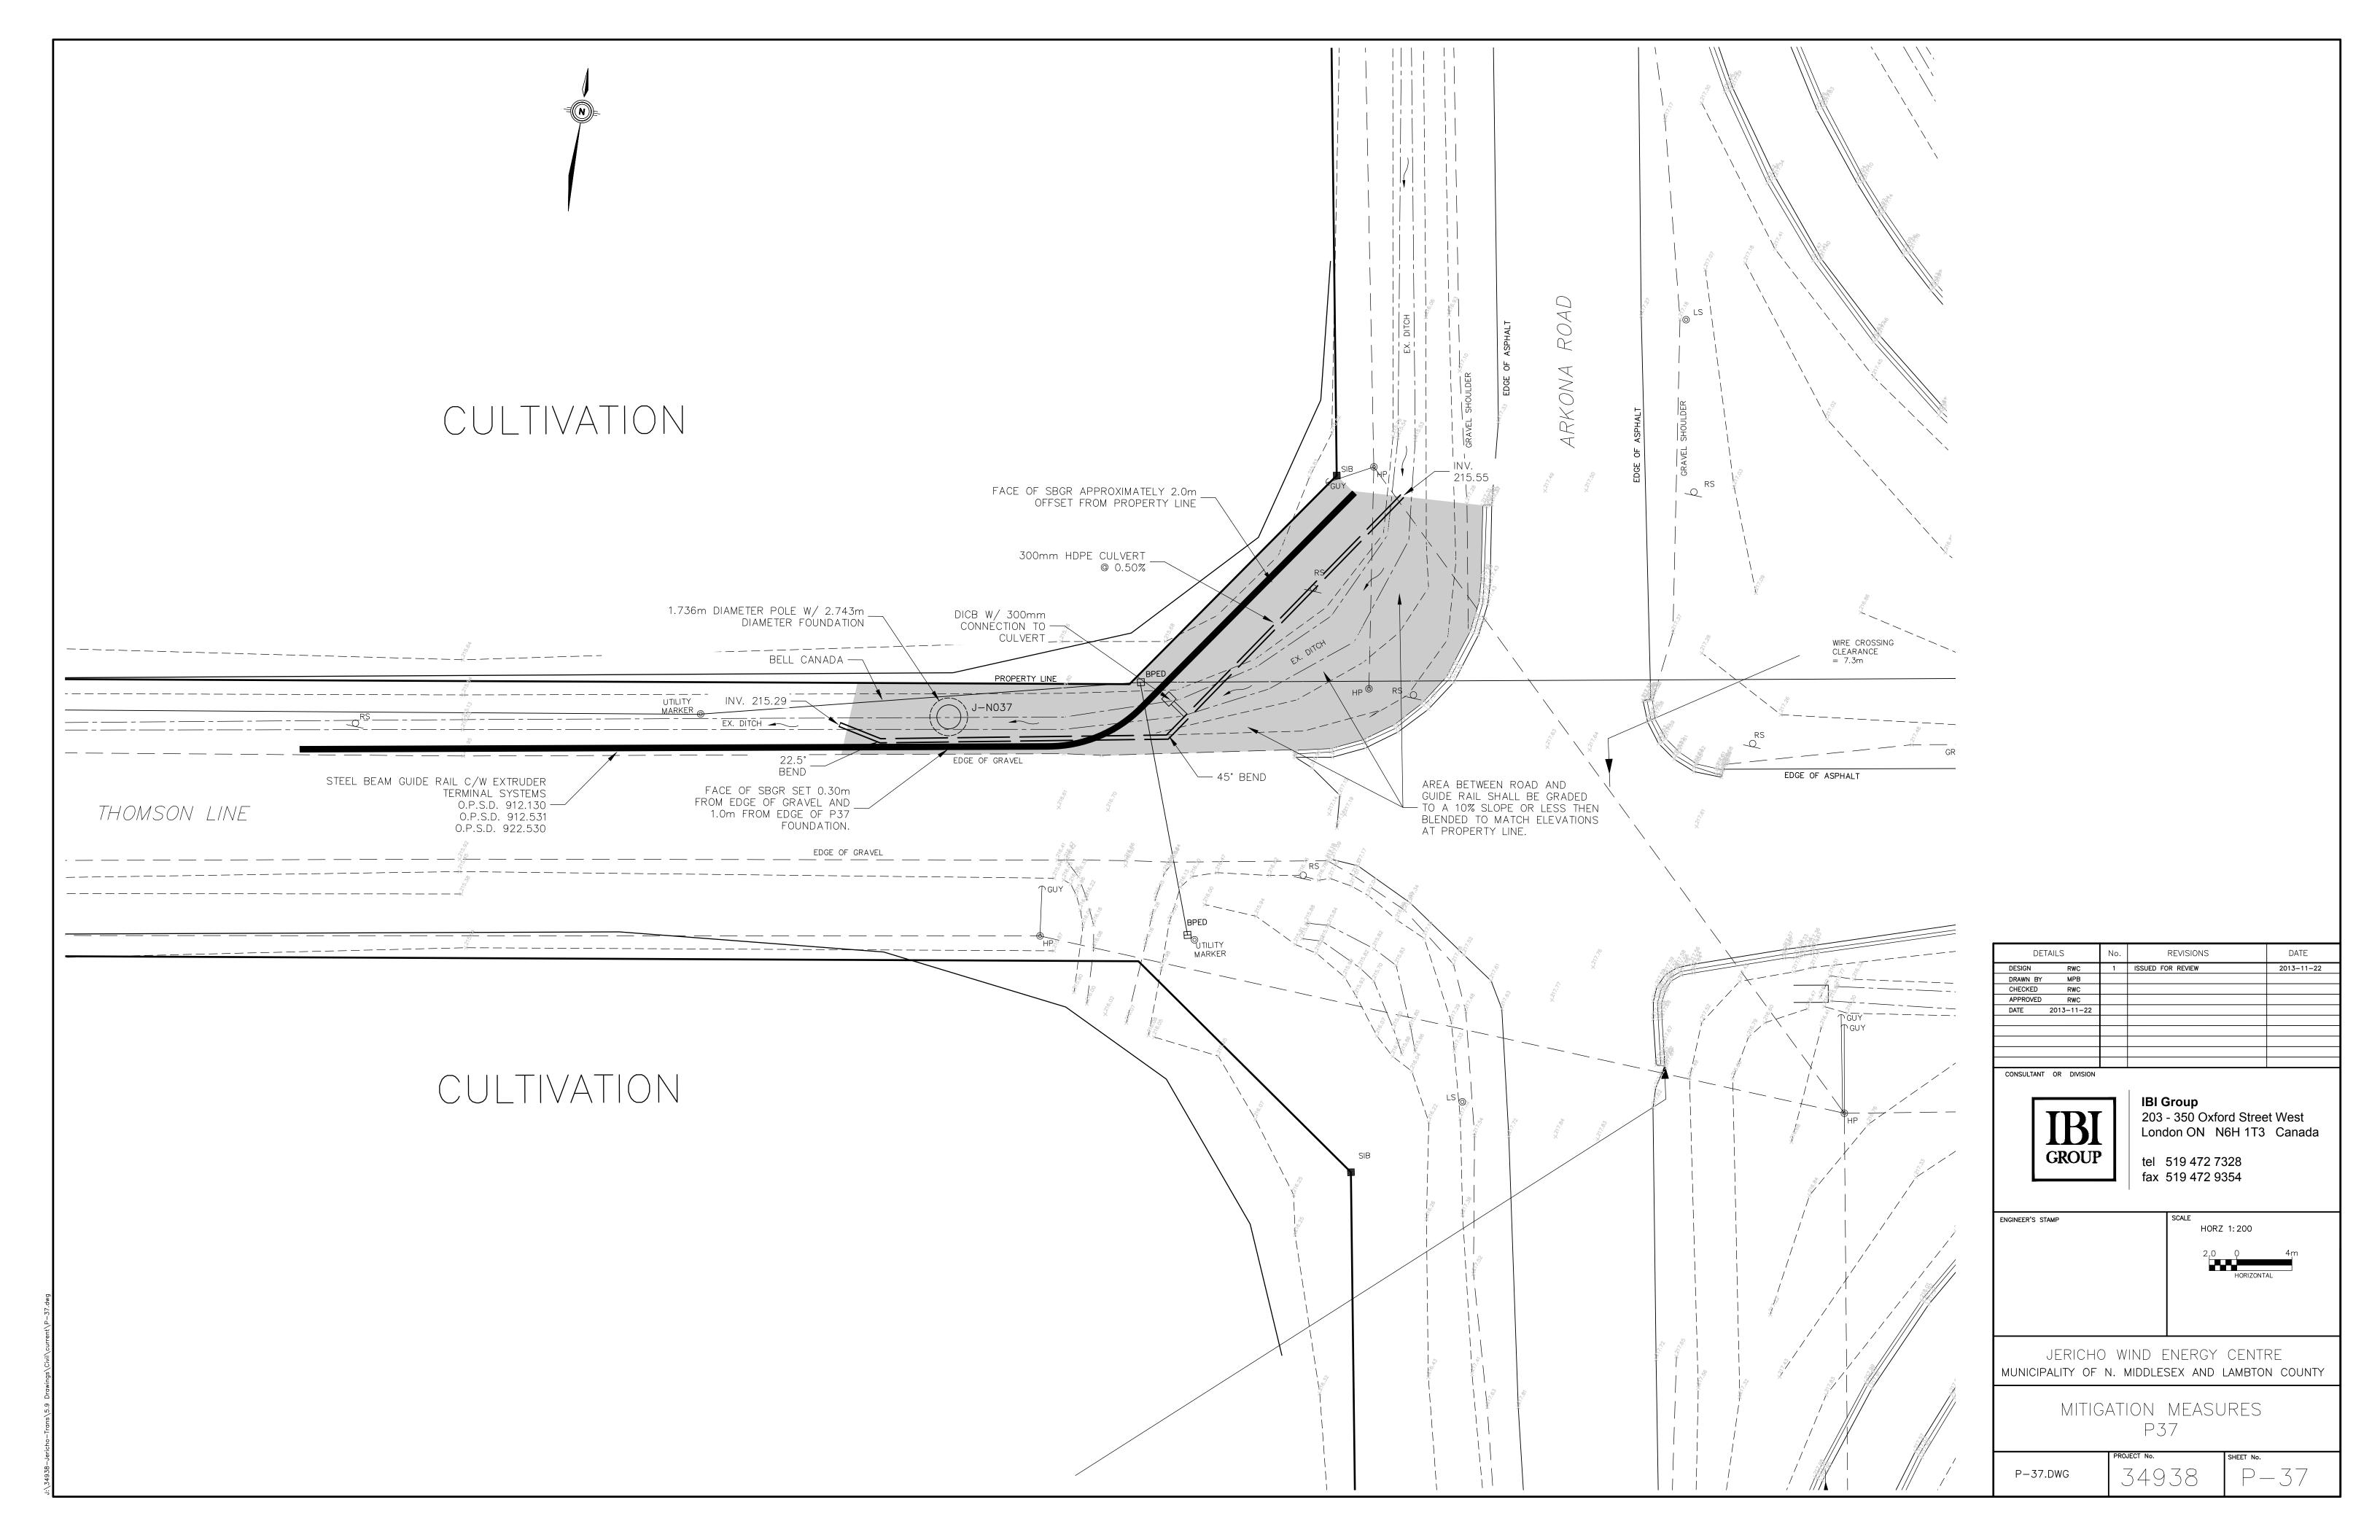

Schedule B5

Jericho Transmission Pole Clearance from Edge of Roadway



Jericho Transmission Line **Lambton County**

Ontario, Canada

* Pole location in private easement

Date: 1/21/2014 PROPRIETARY AND CONFIDENTIAL


Edge of Road Surface


Edge of Shoulder

Closest Face of Pole

		smission Line n County	Jericho Transmission Line Lambton County Pole Distances -Rev K		
	Pole Dista	nces -Rev K			
		Horizontal		Horizontal	
	Pole #	Distance	Dala II	Distance	
		from E/P to	Pole #	from E/P to	
		edge of pole		edge of pole	
	J-N003*	2.60	J-N027*	7.17	
	J-N004	6.78	J-N028	2.52	
	J-N005	6.19	J-N029	2.88	
	J-N006	5.57	J-N030	3.26	
	J-N007	5.83	J-N031	3.44	
	J-N008	6.15	J-N032	3.88	
	J-N009	5.96	J-N033	6.59	
	J-N010	deleted	J-N034	7.73	
	J-N011*	11.89	J-N035	6.80	
^	J-N012*	6.73	J-N036	6.17	
	J-N013*	6.99	J-N037	2.18	
	J-N014*	7.06	J-N038	7.79	
	J-N015*	7.24	J-N039	12.73	
	J-N016*	7.28	J-N040	11.22	
Distance in meters	J-N017*	7.17	J-N041	11.54	
	J-N018*	6.91	J-N042	11.27	
	J-N019*	6.84	J-N043	11.41	
	J-N020*	6.84	J-N044	11.16	
•	J-N021*	7.07	J-N045	7.64	
Pole #	J-N022*	6.84	J-N046	8.85	
	J-N023*	6.58	J-N047	5.98	
	J-N024*	7.54	J-N048	6.04	
	J-N025*	7.53	J-N049	5.80	
	J-N026*	7.55	J-N050	3.41	

Schedule B6 Jericho Typical Culvert Cross Section

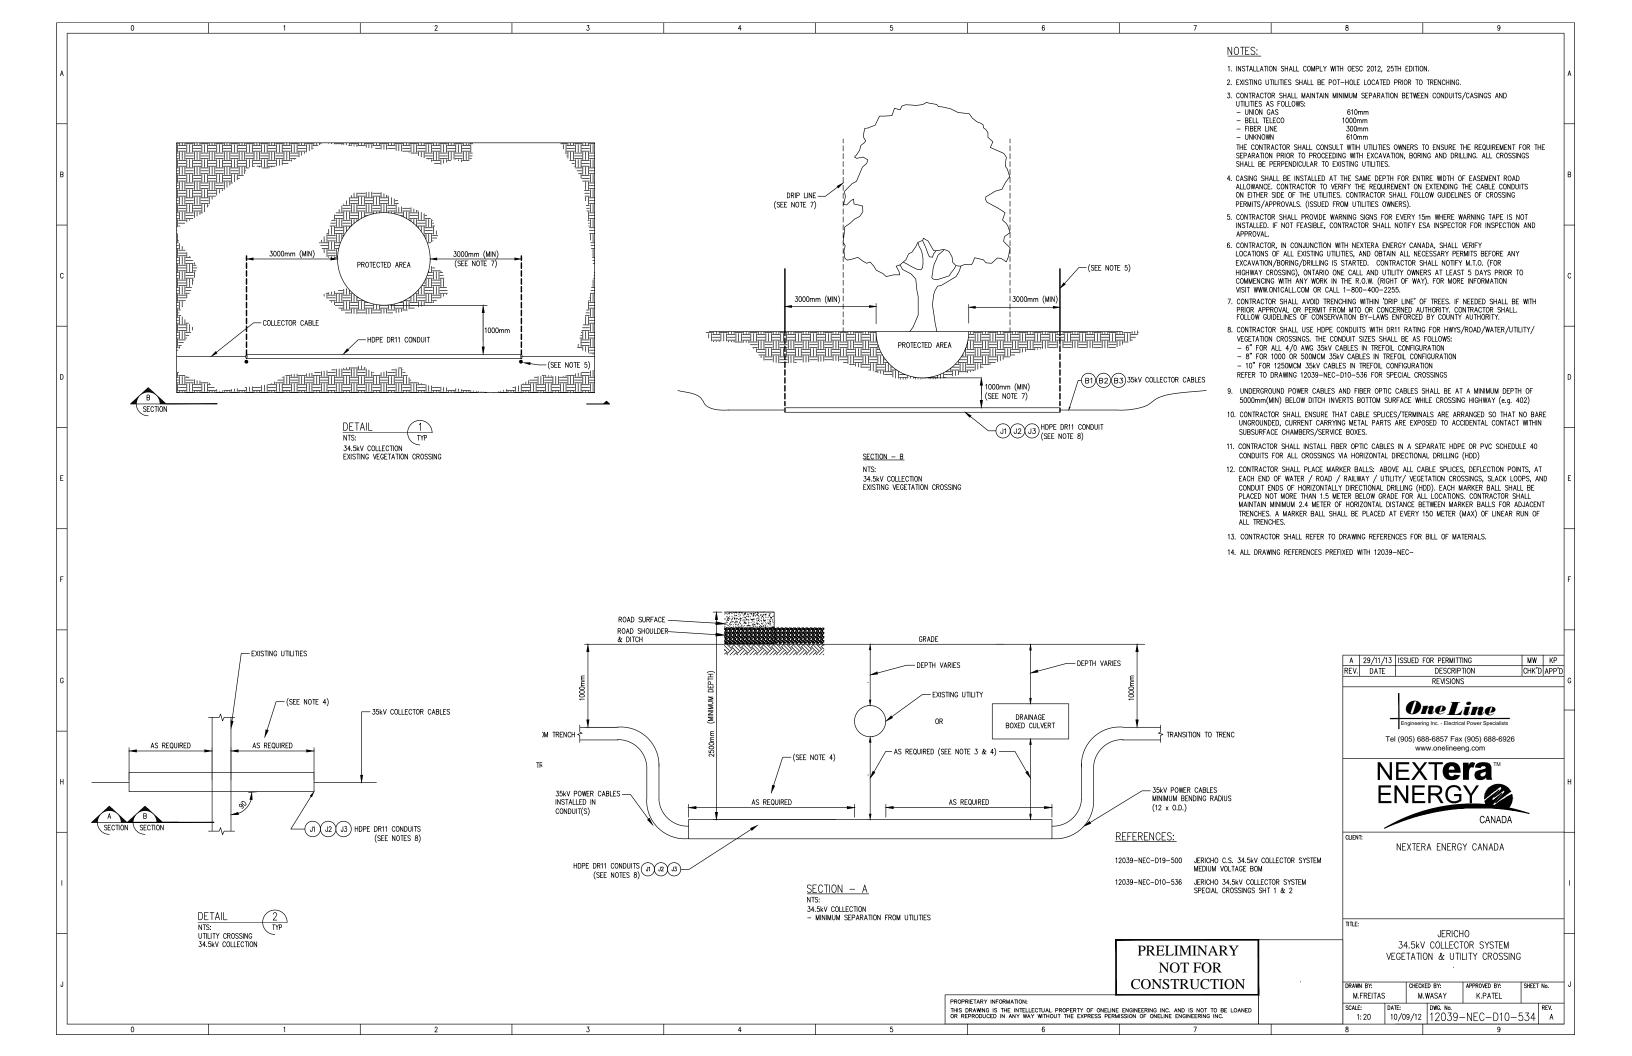

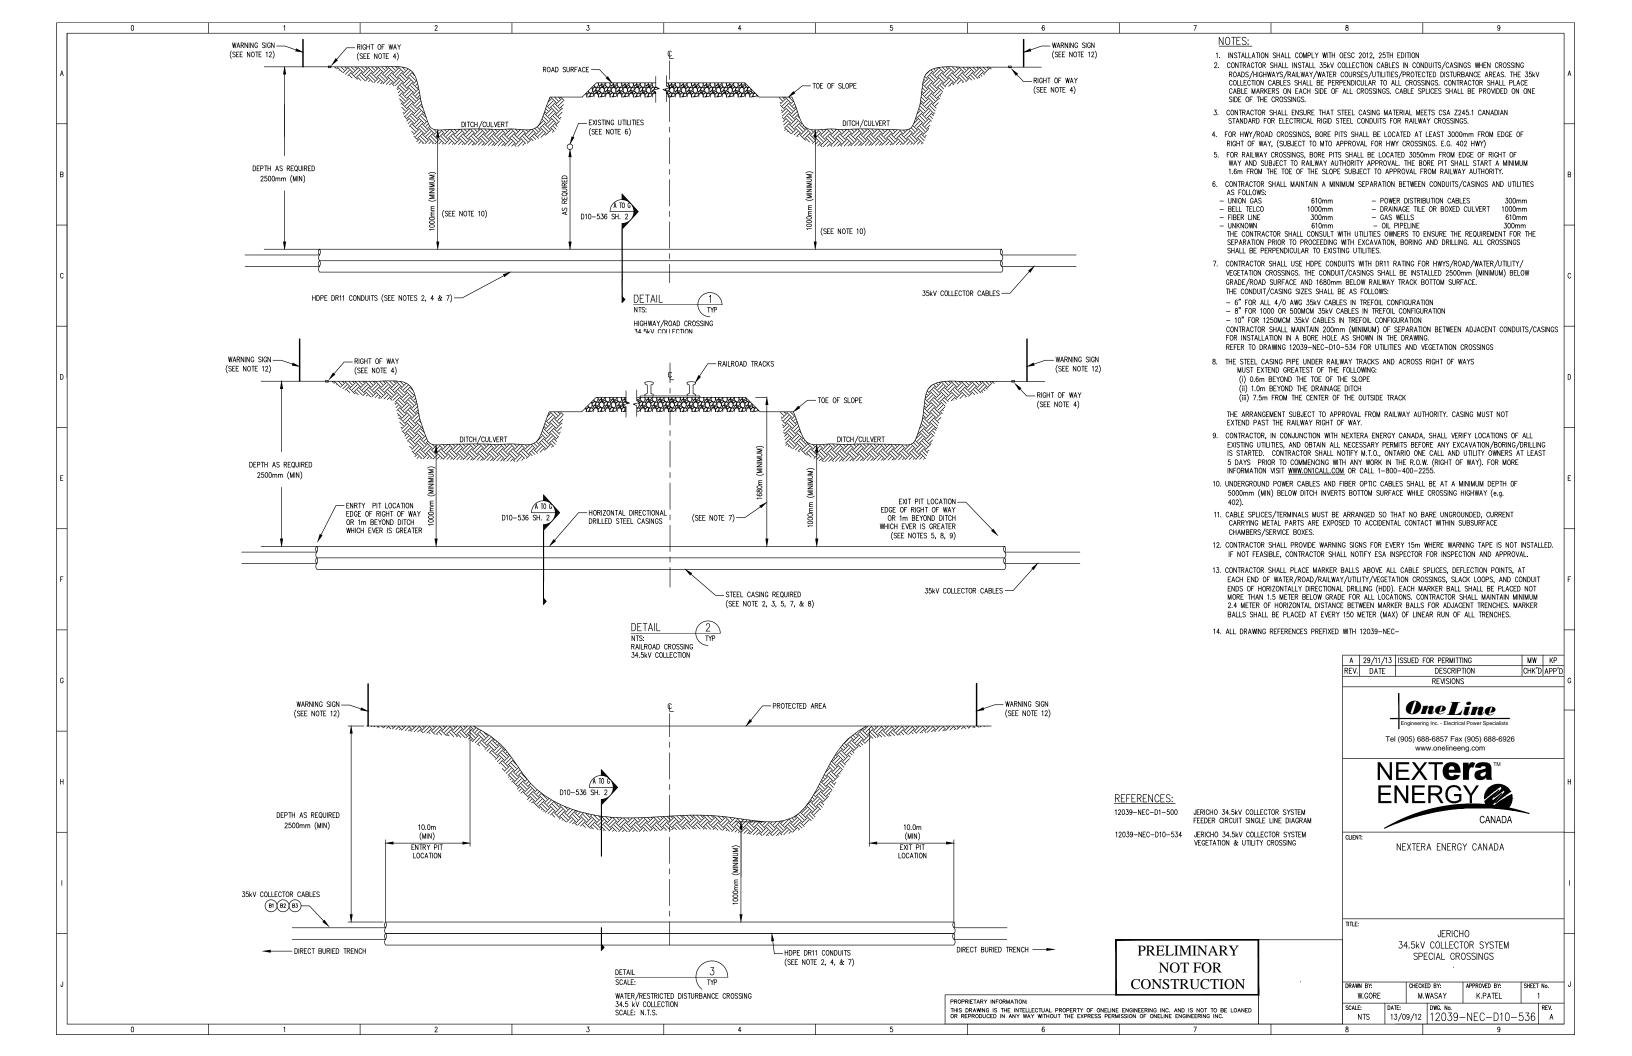

Schedule B7a

Jericho Transmission Line Construction Methods

Support Structure Assembly and Erection

Support structure assembly will begin with auger drilling of a cylindrical shaft in the soil of appropriate diameter and depth to provide necessary support to the structure. For direct-embedded poles, the bottom section of the pole will be centered in this drilled shaft and the gap between the pole and the soil will be backfilled with crushed rock. For base-plated tubular steel poles, a steel reinforcing bar "cage" and an anchor bolt "cage" will be placed in the shaft and the shaft will be filled with concrete to create a sturdy concrete foundation for the structure. Once the concrete has cured to an acceptable strength, the remaining structure will be assembled and erected on top of this foundation.

Equipment required for construction will likely include a combination of cranes, trucks, and augers.

Conductor Stringing

Once a series of support structures have been erected along the transmission line, the conductor stringing phase can begin. Specialized equipment will be attached to insulators that will properly support and protect the conductor during the pulling, tensioning, and sagging operations. Once the conductors and shield wire are in place, and tension and sag have been verified, suspension units are installed at each suspension point to maintain conductor position. Conductor stringing will continue until the transmission line construction is complete.

Schedule B7b

Jericho Distribution (Collection) Construction Methods

In general, wind farm collection power cable will be direct-buried in an open-cut trench at a typical depth below grade of 1 meter in accordance with governing codes and standards. A fiber optic cable for wind farm communication and control will normally be co-located with the power cables. Each excavated trench will be backfilled with compacted native and/or imported material to original grade. Typical equipment for this activity consists of trenchers, backhoes, skid-steer loaders, compactors, utility trucks, and cable reel deployment rigs.


At times, it may be necessary to install power and fiber cables using directional drilling. In these instances, the power and fiber cables will by inside a polyethylene casing.


Schedule B8 Jericho Conductor Horizontal Clearances


The horizontal cable clearance is defined for cable under conductor Blowout Wind condition as specified in CSA C22.3 No.1 Section 5.2.7 & A5.2.7. The horizontal clearance requirements are specified in CSA C22.3 No.1 Table 6 (Railroad), Table 9 (building, signs, fence, etc.), Table 10 (bridges) and Table 35 (flashover for tree pruning).

Schedule B9

Jericho Distribution (Collection) Longitudinal Cross-Sections

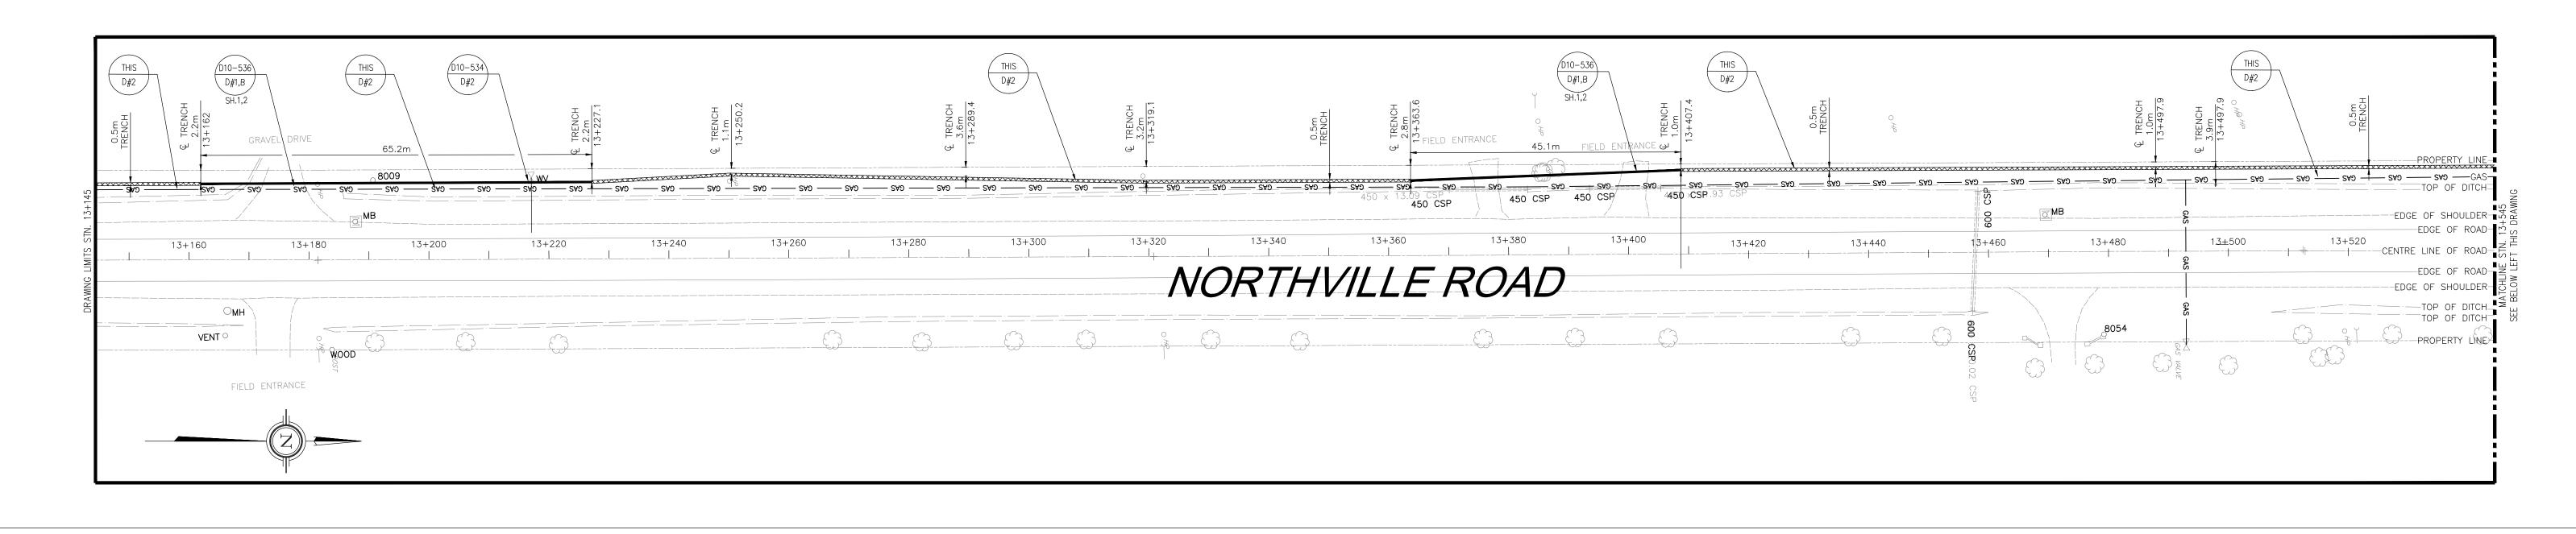

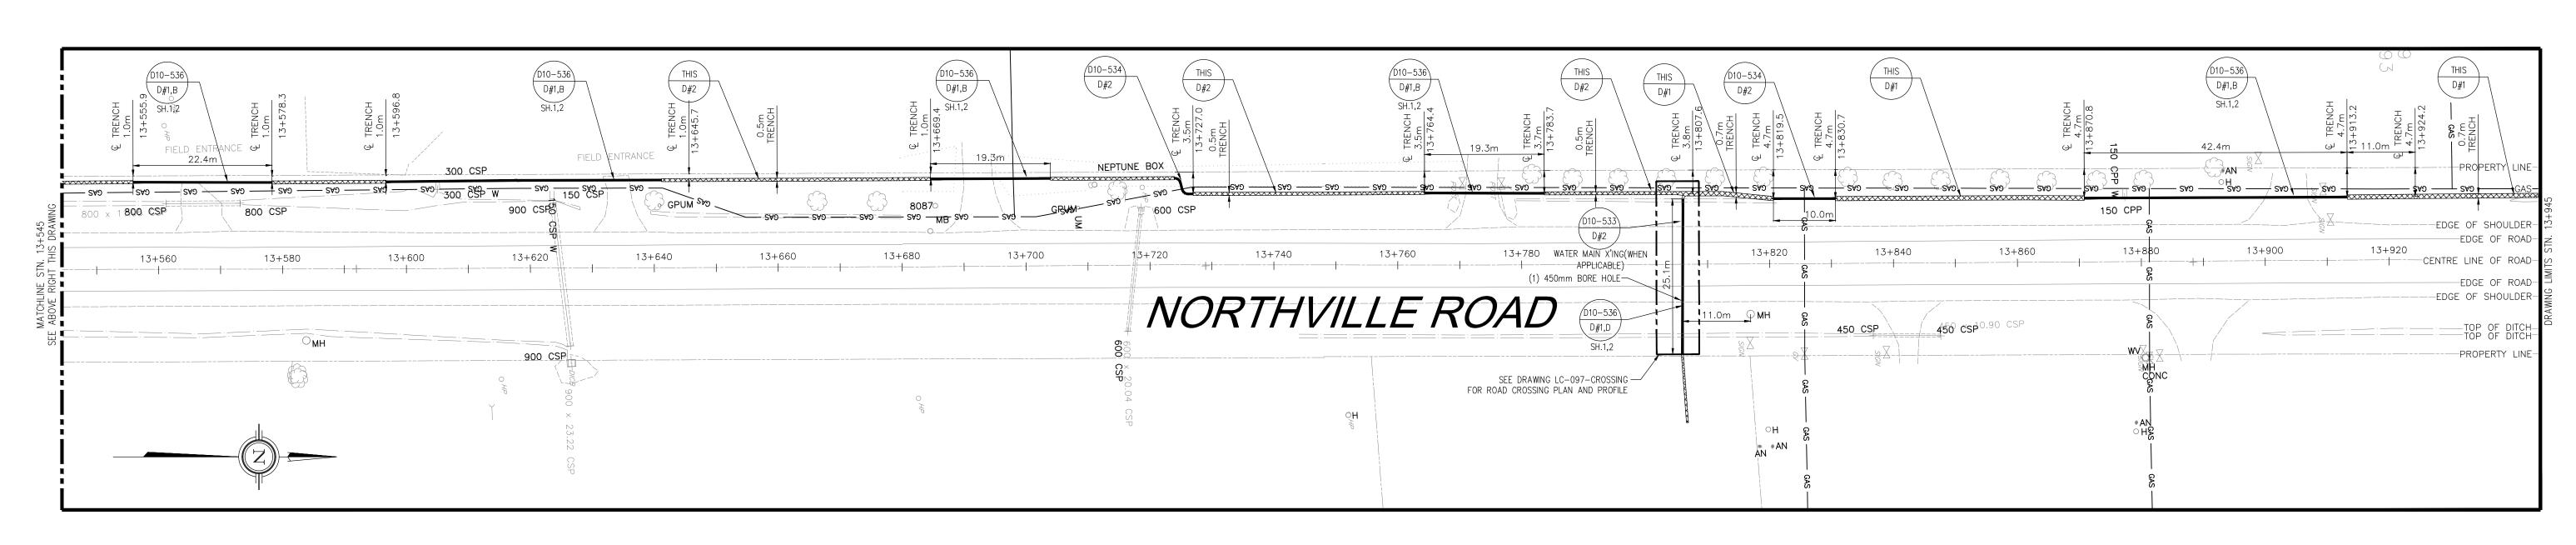

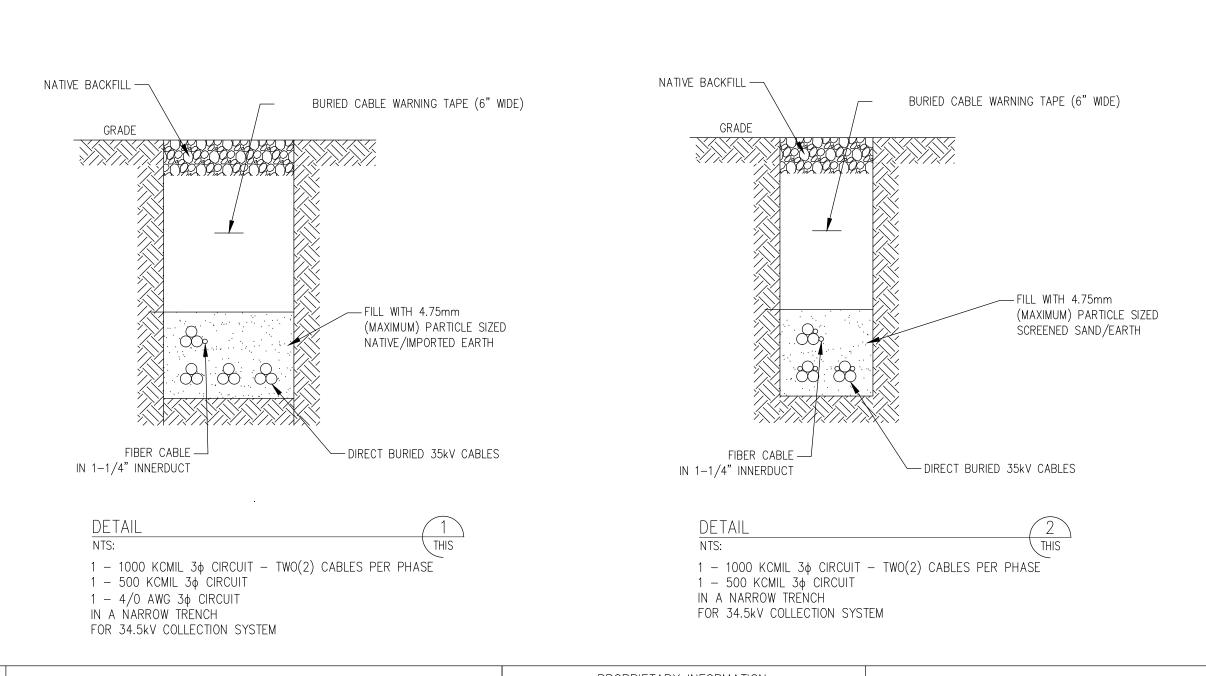

NOTES

350mm DIRECTIONAL BORE (U.N.O.)
34.5kV COLLECTION FEEDER TRENCH

— GAS — UNION GAS LINE

DRAWING REFEREN

<u>LEGEND:</u>

DRAWING REFERENCE PREFIXED BY 12039-NEC-DETAIL REFERENCE, SECTION #

VJB MEDIUM VOLTAGE JUNCTION BOX
MES METAL ENCLOSED SWITCHGEAR

Drawings representing the Distribution (collection) system in county Road Allowance in such form included herein must be submitted prior to construction and after construction in as -built form to the County for review and acceptance.

<u>01L3.</u>

- INSTALLATION SHALL COMPLY WITH OESC 2012, 25TH EDITION.
 CONTRACTOR SHALL EXERCISE/IMPLEMENT ROAD USER AGREEMENT WITH CONCERNED AUTHORITIES OF TOWNSHIP/COUNTY/MUNICIPALITIES FOR THE RIGHT TO USE
- CERTAIN PORTION OF ROAD ALLOWANCES.

 3. CONTRACTOR SHALL REPORT ANY OBSTRUCTIONS AFFECTING THEIR PERFORMANCE BEFORE PROCEEDING WITH ANY WORK.
- 4. CONTRACTOR SHALL VERIFY LOCATIONS OF ALL EXISTING UTILITIES BEFORE ANY EXCAVATION/BORING/DRILLING IS STARTED. CONTRACTOR MUST NOTIFY ONTARIO ONE CALL AND UTILITY OWNERS AT LEAST 5 DAYS PRIOR TO COMMENCING ANY WORK. FOR MORE INFORMATION, VISIT WWW.ON1CALL.COM OR CALL 1-800-400-2255.
- 5. CONTRACTOR SHALL USE HDPE DR11 RATED CONDUITS FOR ROAD, HIGHWAY, UTILITIES, VEGETATION, AND PROTECTED AREA CROSSINGS FOR INSTALLATION VIA HORIZONTAL DIRECTIONAL DRILLING (HDD). CONTRACTOR SHALL USE STEEL CASINGS FOR RAILWAY CROSSINGS VIA HDD. CONTRACTOR SHALL INSTALL FIBER OPTIC CABLES IN A SEPARATE HDPE/PVC SCH. 40 CONDUITS FOR ALL CROSSINGS.
- 6. THE CONTRACTOR MUST FIELD CHECK AND VERIFY
 INSTALLATION DETAIL SUCH AS DIMENSION, ELEVATION, SITE
 CONDITION ETC. AND REPORT ANY DESCRIPANCIES TO THE SITE
 MANAGER (ENGINEER) PRIOR TO COMMENCING ANY
 WORK/FABRICATION.
- 7. DRAWINGS BASED ON CALLON DIETZ SITE PLAN DRAWINGS.8. ALL DRAWING REFERENCES PREFIXED WITH 12039-NEC-

REFERENCE DRAWINGS:

12039-NEC-D10-536, SHT.1 34.5kV COLLECTOR SYSTEM SPECIAL CROSSINGS
12039-NEC-D10-536, SHT.2 34.5kV COLLECTOR SYSTEM SPECIAL CROSSINGS
LC-097-CROSSING CABLE CROSSING NORTHVILLE ROAD AT TURBINE 58

PRELIMINARY
NOT FOR
CONSTRUCTION




Tel (905) 688-6857 Fax (905) 688-6926 www.onelineeng.com PROPRIETARY INFORMATION:
THIS DRAWING IS THE INTELLECTUAL PROPERTY OF
ONELINE ENGINEERING INC. AND IS NOT TO BE LOANED
OR REPRODUCED IN ANY WAY WITHOUT THE EXPRESS
PERMISSION OF ONELINE ENGINEERING INC.




REV.	DATE 24/01/2013	DESCRIPTION PERMITTING SAMPLE	CHK'D APP'D	DRAWN BY: B.BREWSTER	TITLE:	NEXTERA ENERGY CANADA
				CHECKED BY:		NEATENA ENENGT CANADA
				APPROVED BY:		JERICHO 34.5kV COLLECTOR SYSTEM LAMBTON COUNTY DETAILED PLAN
				DATE: 24/01/14	SCALE:	UNDERGROUND CABLE LAYOUT
				27/01/14	SOALL.	ITS $\left \begin{array}{c} DWG. \ No. 12039 - NEC - D10 - 5XX \right SHEET \ No. \ X \ \left \begin{array}{c} REV. \ A \end{array} \right $

Schedule B10

Jericho Distribution (Collection) Perpendicular Cross-Sections

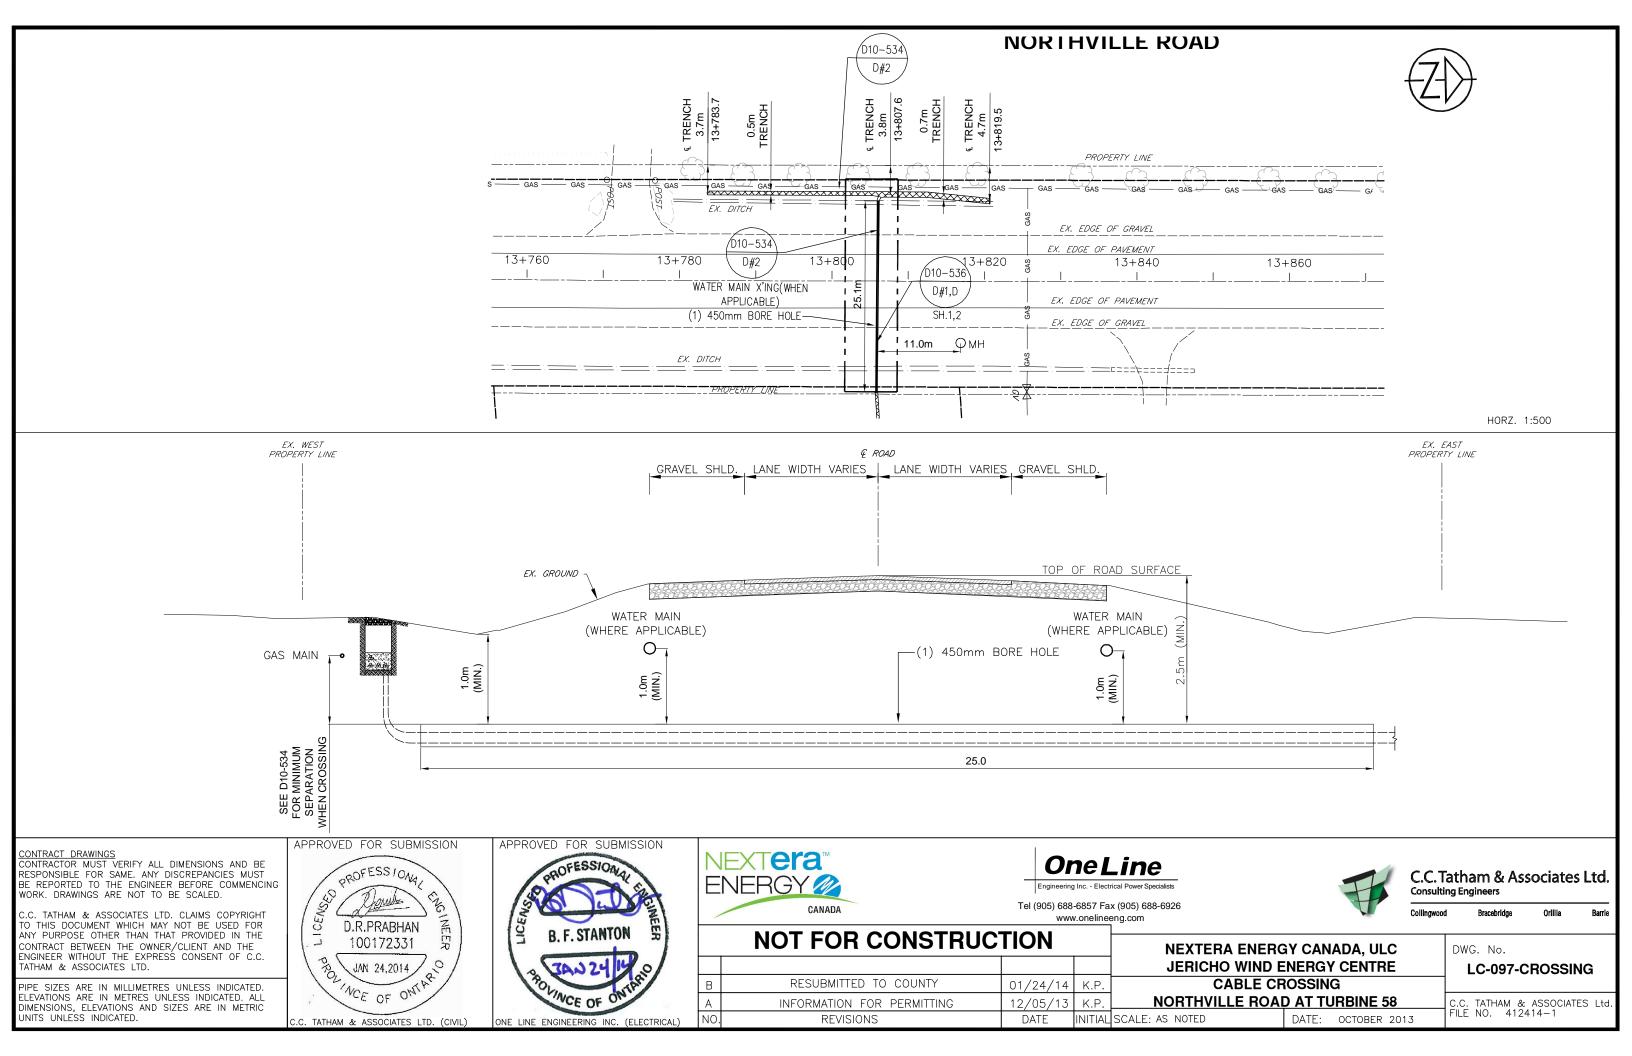

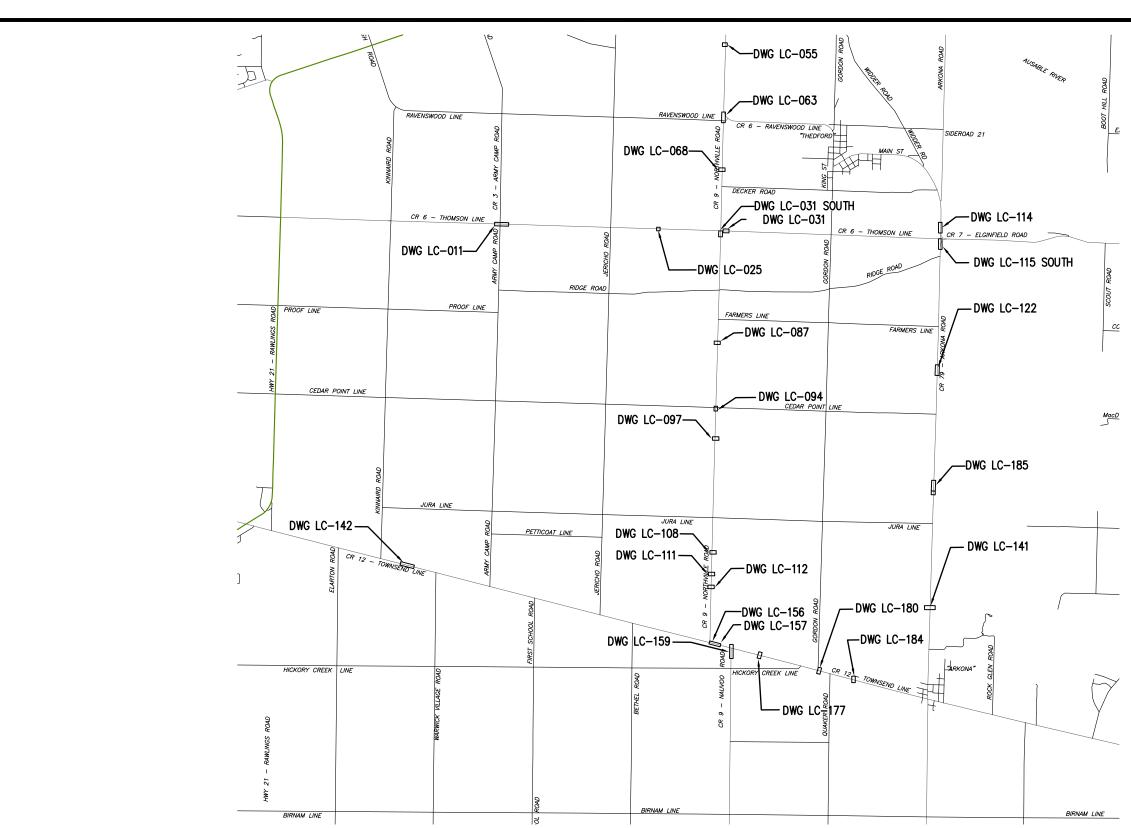

CONTRACT DRAWINGS
CONTRACTOR MUST VERIFY ALL DIMENSIONS AND BE
RESPONSIBLE FOR SAME. ANY DISCREPANCIES MUST BE REPORTED TO THE ENGINEER BEFORE COMMENCING WORK. DRAWINGS ARE NOT TO BE SCALED.

.C. TATHAM & ASSOCIATES LTD. CLAIMS COPYRIGHT TO THIS DOCUMENT WHICH MAY NOT BE USED FOR ANY PURPOSE OTHER THAN THAT PROVIDED IN THE CONTRACT BETWEEN THE OWNER/CLIENT AND THE ENGINEER WITHOUT THE EXPRESS CONSENT OF C.C. TATHAM & ASSOCIATES LTD.

PIPE SIZES ARE IN MILLIMETRES UNLESS INDICATED. ELEVATIONS ARE IN METRES UNLESS INDICATED. ALL DIMENSIONS, ELEVATIONS AND SIZES ARE IN METRIC JNITS UNLESS INDICATED.

APPROVED FOR SUBMISSION



APPROVED FOR SUBMISSION



NEXTERA ENERGY



Tel (905) 688-6857 Fax (905) 688-6926 www.onelineeng.com



C.C. Tatham & Associates Ltd. **Consulting Engineers**

DWG. No.

LC-INDEX 2

CROSSING INDEX SHEET


NEXTERA ENERGY CANADA, ULC


JERICHO WIND ENERGY CENTRE

C.C. TATHAM & ASSOCIATES Ltd. FILE NO. 412414-1 DATE: OCTOBER 2013

NOT FOR CONSTRUCTION

В RESUBMITTED TO COUNTY FOR PERMITTING 12/05/13 K.P. INFORMATION FOR PERMITTING 06/11/13 K.P. NO. REVISIONS DATE INITIAL SCALE: N.T.S.

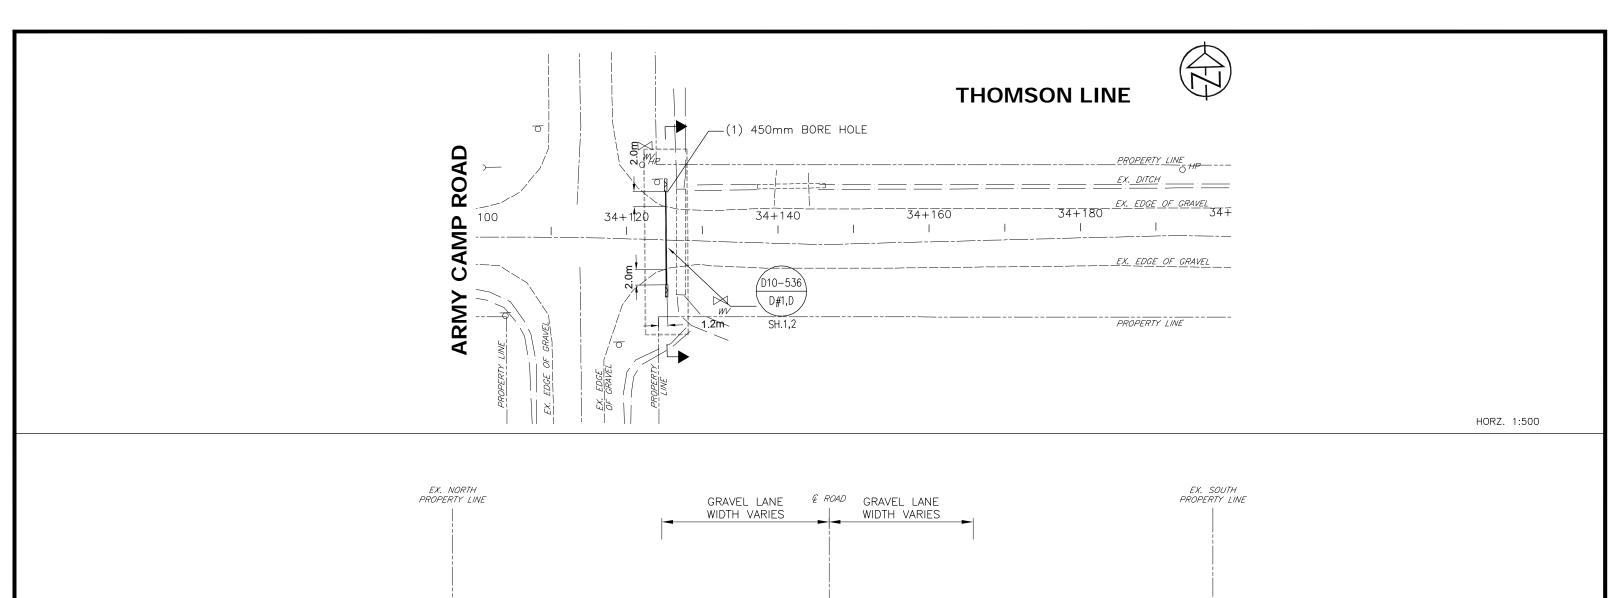

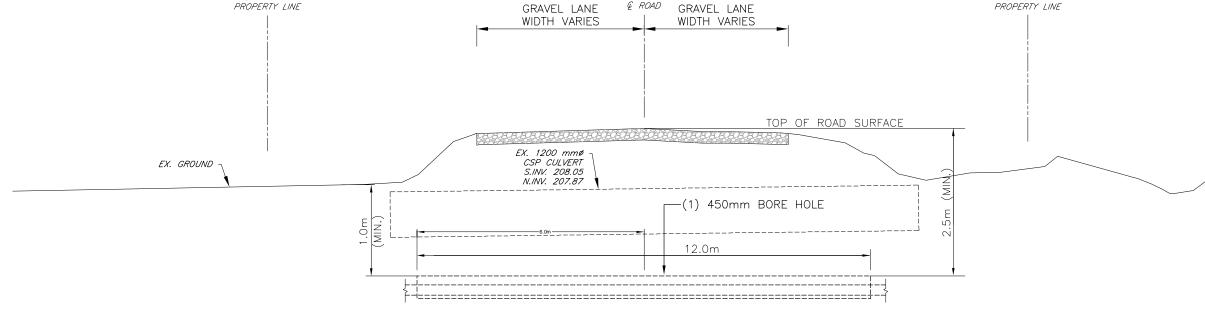

Orillia

CONTRACT DRAWINGS

CONTRACTOR MUST VERIFY ALL DIMENSIONS AND BE RESPONSIBLE FOR SAME. ANY DISCREPANCIES MUST BE REPORTED TO THE ENGINEER BEFORE COMMENCING WORK. DRAWINGS ARE NOT TO BE SCALED.

C.C. TATHAM & ASSOCIATES LTD. CLAIMS COPYRIGHT TO THIS DOCUMENT WHICH MAY NOT BE USED FOR ANY PURPOSE OTHER THAN THAT PROVIDED IN THE CONTRACT BETWEEN THE OWNER/CLIENT AND THE ENGINEER WITHOUT THE EXPRESS CONSENT OF C.C. TATHAM & ASSOCIATES LTD.

PIPE SIZES ARE IN MILLIMETRES UNLESS INDICATED. ELEVATIONS ARE IN METRES UNLESS INDICATED. ALL DIMENSIONS, ELEVATIONS AND SIZES ARE IN METRIC INITS UNLESS INDICATED.





ONE LINE ENGINEERING INC. (ELECTRICAL

APPROVED FOR SUBMISSION



RESUBMITTED TO COUNTY FOR PERMITTING

INFORMATION FOR PERMITTING

REVISIONS



Tel (905) 688-6857 Fax (905) 688-6926 www.onelineeng.com

K.P.

12/05/13

06/11/13

DATE




C.C. Tatham & Associates Ltd. Consulting Engineers


Bracebridge

NEXTERA ENERGY CANADA, ULC JERICHO WIND ENERGY CENTRE CABLE CROSSING

DWG. No. LC-011-CROSSING

THOMSON LINE AT ARMY CAMP ROAD INITIAL SCALE: AS NOTED DATE: OCTOBER 2013

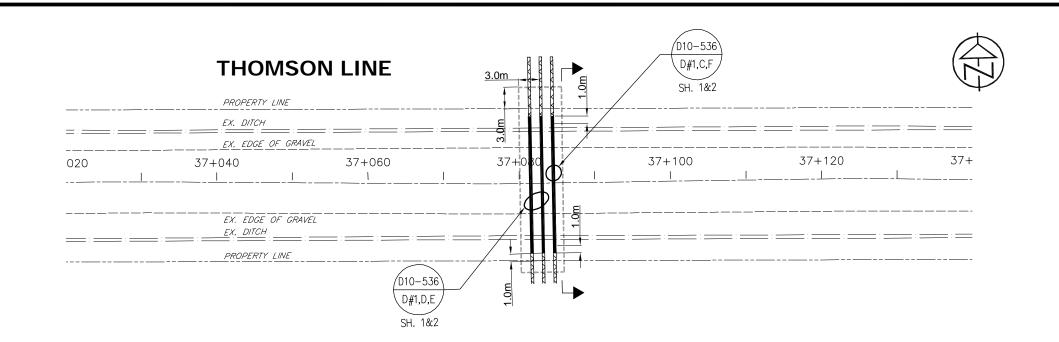

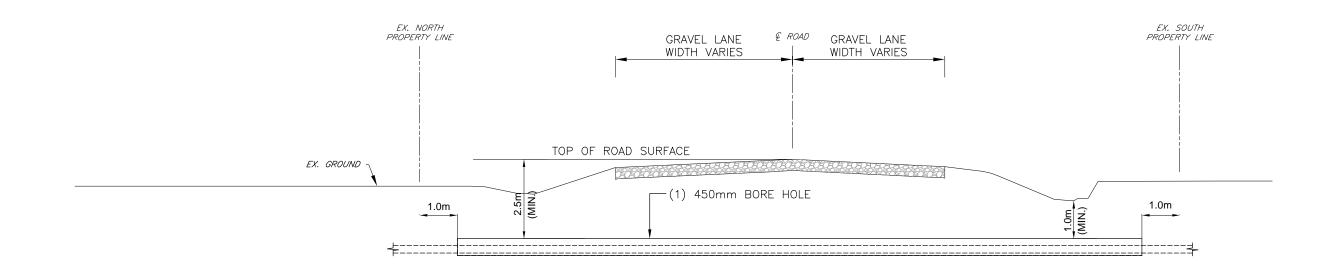


CONTRACT DRAWINGS
CONTRACTOR MUST VERIFY ALL DIMENSIONS AND BE
RESPONSIBLE FOR SAME. ANY DISCREPANCIES MUST
BE REPORTED TO THE ENGINEER BEFORE COMMENCING
WORK. DRAWINGS ARE NOT TO BE SCALED.

C.C. TATHAM & ASSOCIATES LTD. CLAIMS COPYRIGHT TO THIS DOCUMENT WHICH MAY NOT BE USED FOR ANY PURPOSE OTHER THAN THAT PROVIDED IN THE CONTRACT BETWEEN THE OWNER/CLIENT AND THE ENGINEER WITHOUT THE EXPRESS CONSENT OF C.C. TATHAM & ASSOCIATES LTD.

PIPE SIZES ARE IN MILLIMETRES UNLESS INDICATED. ELEVATIONS ARE IN METRES UNLESS INDICATED. ALL DIMENSIONS, ELEVATIONS AND SIZES ARE IN METRIC UNITS UNLESS INDICATED.



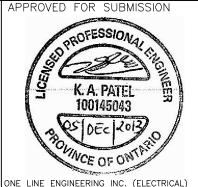



REVISIONS



Tel (905) 688-6857 Fax (905) 688-6926 www.onelineeng.com

DATE



DATE: OCTOBER 2013

C.C. Tatham & Associates Ltd.
Consulting Engineers

Collingwood Bracebridge

-

NOT FOR CONSTRUCTION

NEXTERA ENERGY CANADA, ULC
JERICHO WIND ENERGY CENTRE

RESUBMITTED TO COUNTY FOR PERMITTING 12/05/13 K.P.


INFORMATION FOR PERMITTING 06/11/13 K.P.


THOMSON LINE AT TURBINE 26

INITIAL SCALE: AS NOTED

DWG. No. **LC-025-CROSSING**

Orillia

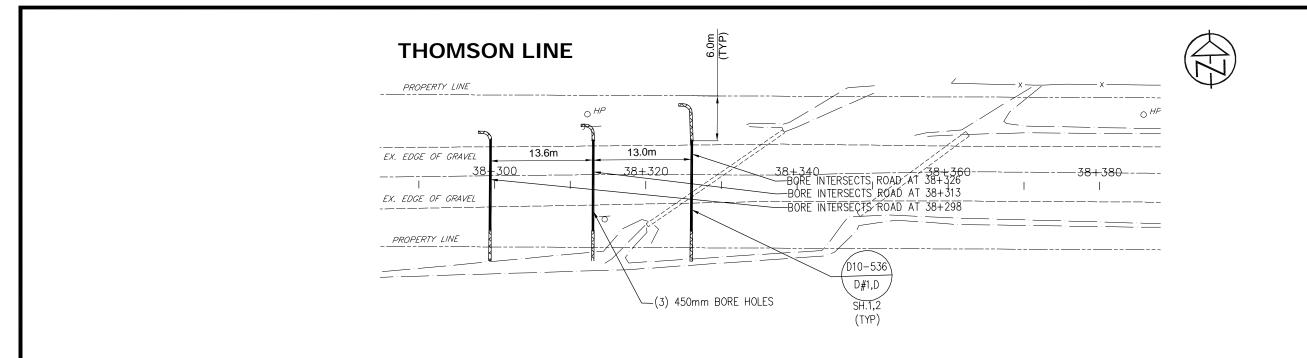

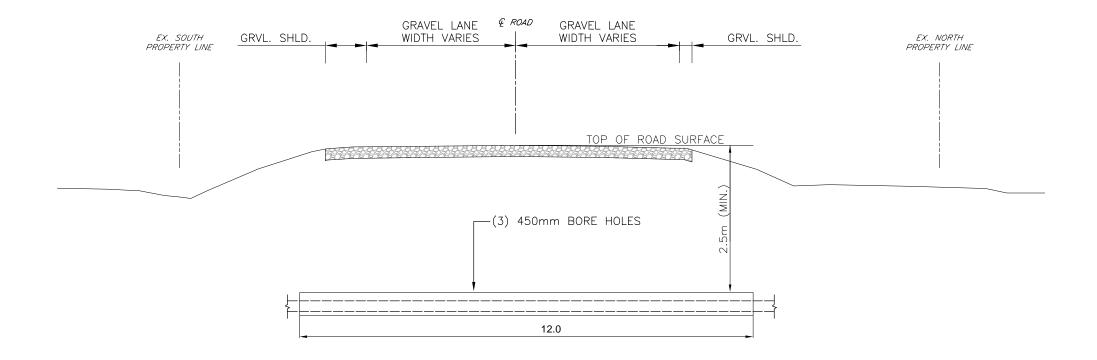

HORZ. 1:100

Orillia

CONTRACT DRAWINGS CONTRACTOR MUST VERIFY ALL DIMENSIONS AND BE RESPONSIBLE FOR SAME. ANY DISCREPANCIES MUST BE REPORTED TO THE ENGINEER BEFORE COMMENCING

WORK. DRAWINGS ARE NOT TO BE SCALED. C.C. TATHAM & ASSOCIATES LTD. CLAIMS COPYRIGHT

TO THIS DOCUMENT WHICH MAY NOT BE USED FOR ANY PURPOSE OTHER THAN THAT PROVIDED IN THE CONTRACT BETWEEN THE OWNER/CLIENT AND THE ENGINEER WITHOUT THE EXPRESS CONSENT OF C.C. TATHAM & ASSOCIATES LTD.

PIPE SIZES ARE IN MILLIMETRES UNLESS INDICATED. ELEVATIONS ARE IN METRES UNLESS INDICATED. ALL DIMENSIONS, ELEVATIONS AND SIZES ARE IN METRIC INITS UNLESS INDICATED.





ONE LINE ENGINEERING INC. (ELECTRICAL)

NEXTERA ENERGY CANADA

NOT

RESUBMITT

REVISIONS



Tel (905) 688-6857 Fax (905) 688-6926 www.onelineeng.com



C.C. Tatham & Associates Ltd. Consulting Engineers


Bracebridge


DWG. No. LC-031-CROSSING


FOR CONSTRUCTION	NEXTERA ENERGY CANADA, ULC
	JERICHO WIND ENERGY CENTRE
) TO COUNTY FOR PERMITTING 12/05/13 K.P.	CABLE CROSSING
MATION FOR PERMITTING 06/11/13 KP THON	ISON LINE EAST OF NORTHVILLE F


DATE


06/11/13 K.P. THOMSON LINE EAST OF NORTHVILLE ROAD C.C. TATHAM & ASSOCIATES Ltd INITIAL SCALE: AS NOTED DATE: OCTOBER 2013

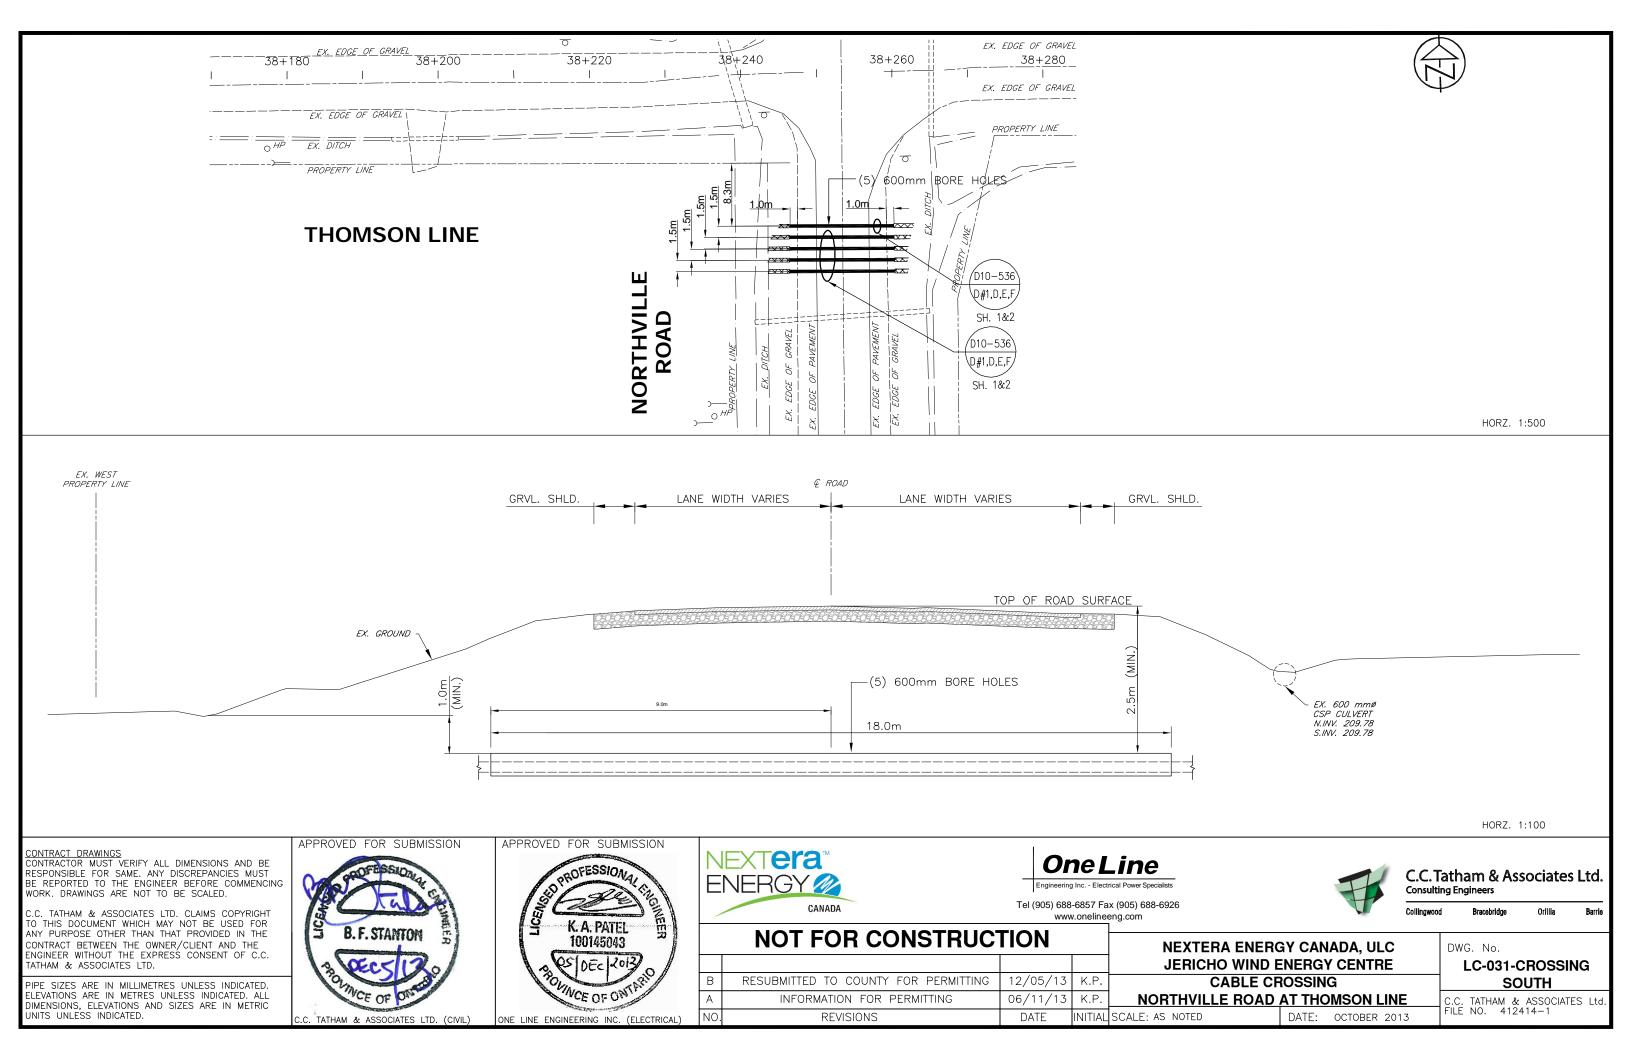

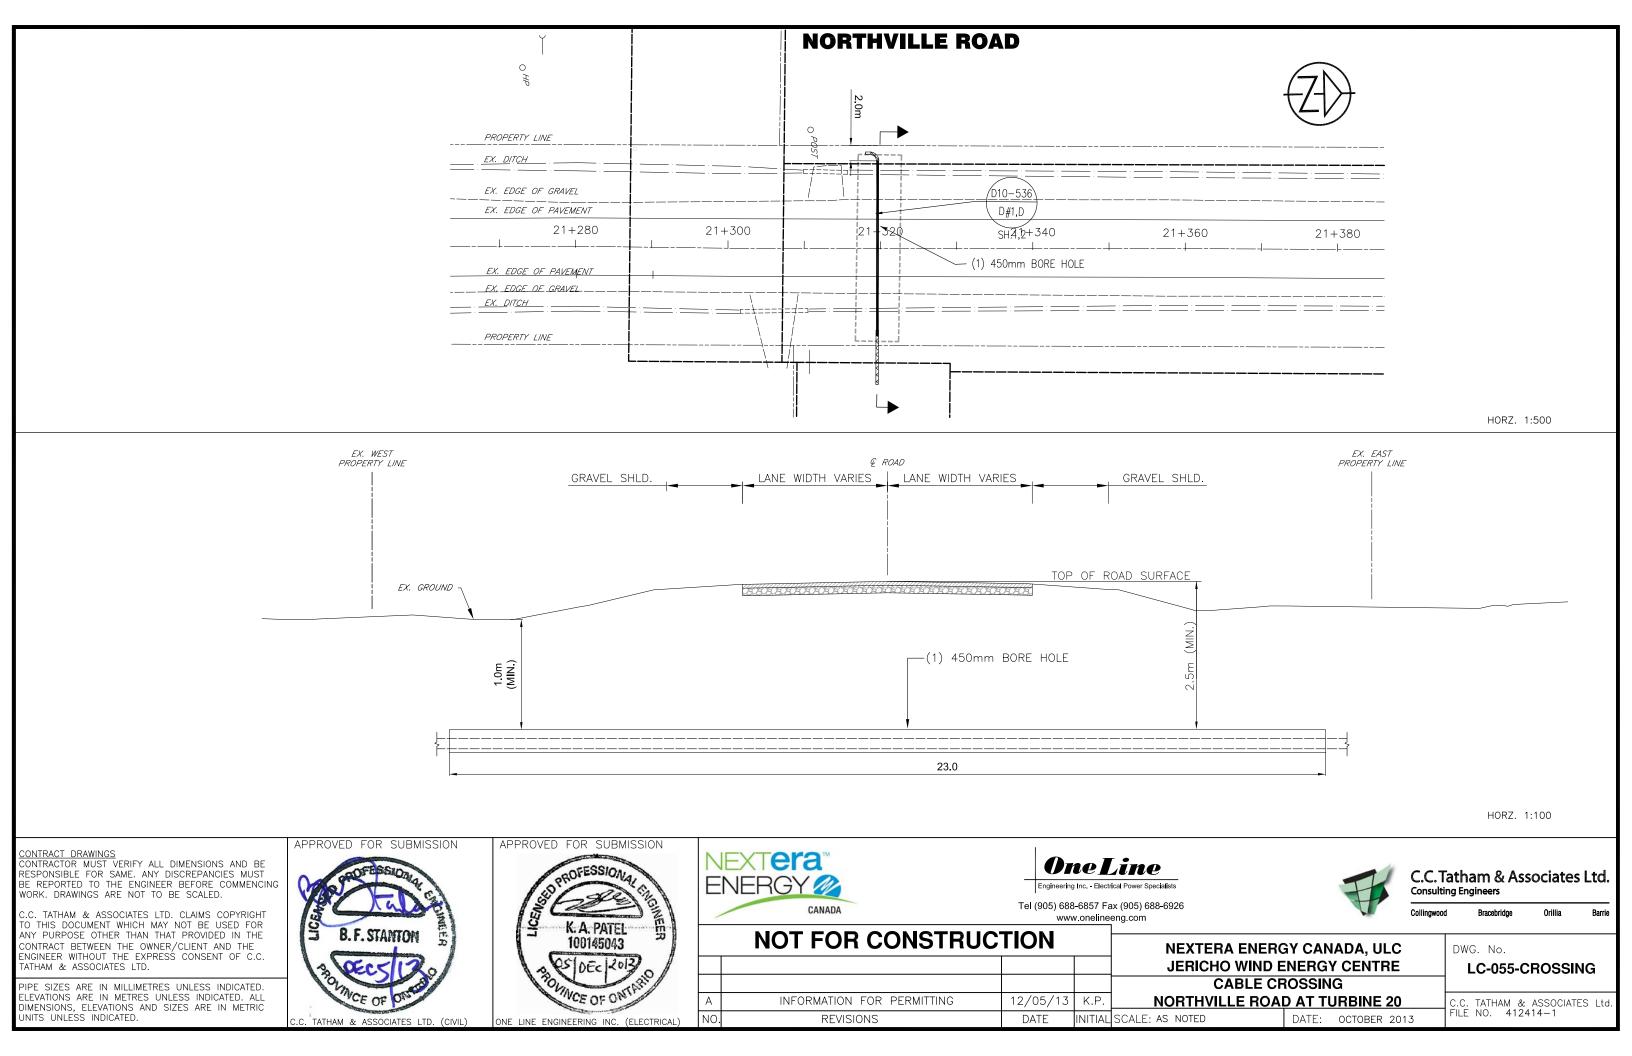

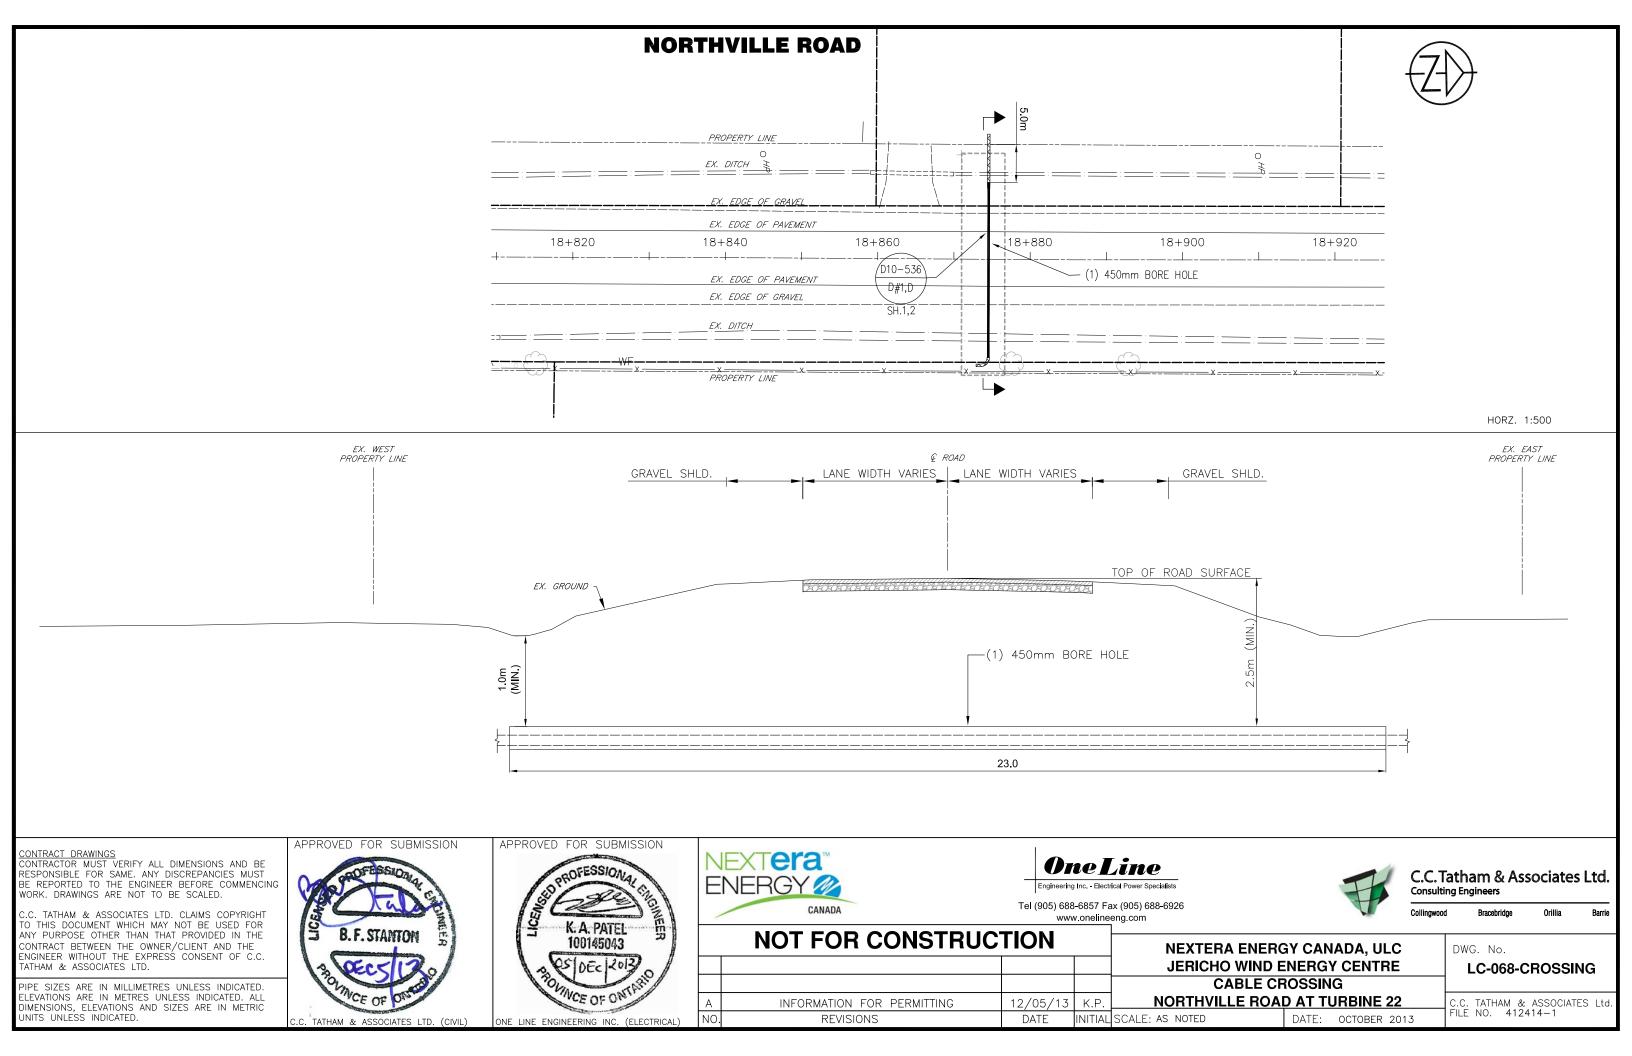

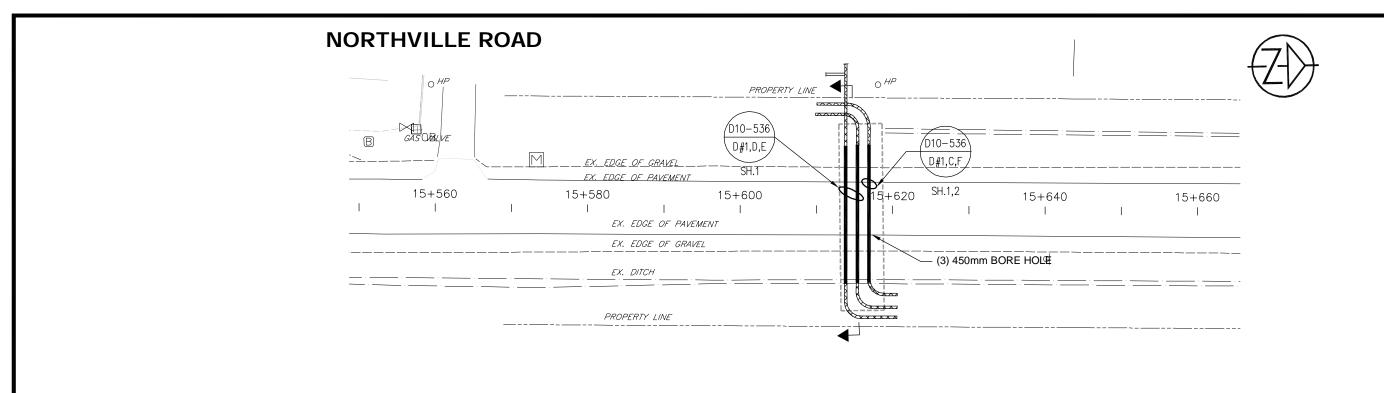

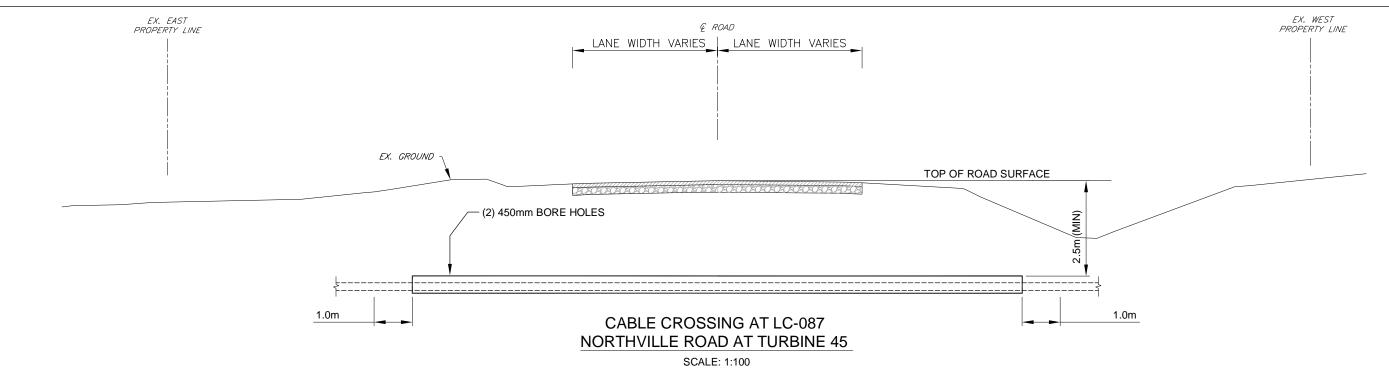

HORZ. 1:100

CONTRACT DRAWINGS CONTRACTOR MUST VERIFY ALL DIMENSIONS AND BE RESPONSIBLE FOR SAME. ANY DISCREPANCIES MUST BE REPORTED TO THE ENGINEER BEFORE COMMENCING WORK. DRAWINGS ARE NOT TO BE SCALED.

C.C. TATHAM & ASSOCIATES LTD. CLAIMS COPYRIGHT TO THIS DOCUMENT WHICH MAY NOT BE USED FOR ANY PURPOSE OTHER THAN THAT PROVIDED IN THE CONTRACT BETWEEN THE OWNER/CLIENT AND THE ENGINEER WITHOUT THE EXPRESS CONSENT OF C.C. TATHAM & ASSOCIATES LTD.

PIPE SIZES ARE IN MILLIMETRES UNLESS INDICATED. ELEVATIONS ARE IN METRES UNLESS INDICATED. ALL DIMENSIONS, ELEVATIONS AND SIZES ARE IN METRIC UNITS UNLÉSS INDICATED.





APPROVED FOR SUBMISSION





REVISIONS

В

NO.



Tel (905) 688-6857 Fax (905) 688-6926 www.onelineeng.com



C.C. Tatham & Associates Ltd. **Consulting Engineers**


DWG. No.


Orillia Bracebridge

NEXTERA ENERGY CANADA	NOT FOR CONSTRUCTION		
JERICHO WIND ENERGY CEN			
05/13 K.P. CABLE CROSSING	K.F	12/05/13	RESUBMITTED TO COUNTY FOR PERMITTING
11/13 K.P. NORTHVILLE ROAD AT TURBI	K.F	06/11/13	INFORMATION FOR PERMITTING

DATE

CROSSING **NORTHVILLE ROAD AT TURBINE 45** INITIAL SCALE: AS NOTED DATE: OCTOBER 2013 LC-087-CROSSING

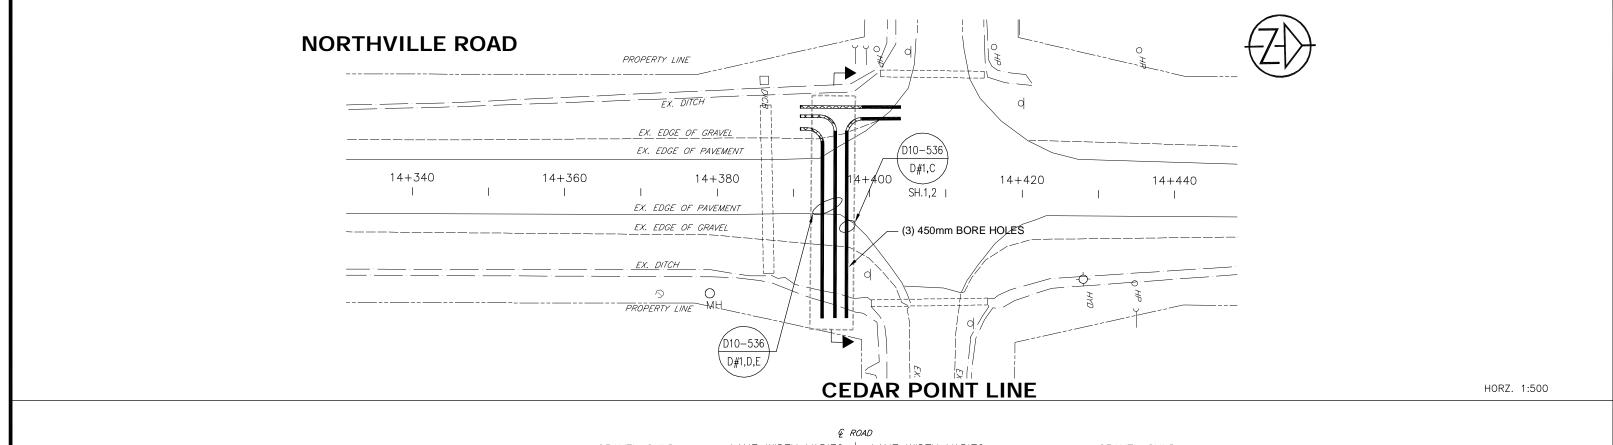

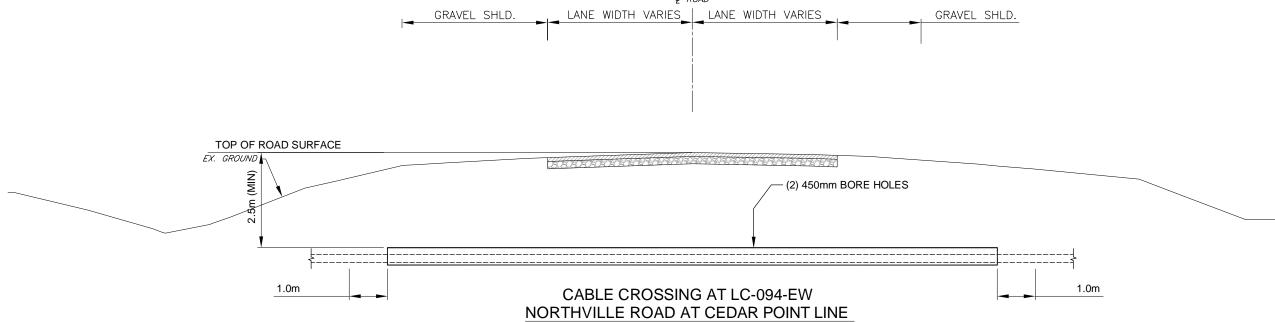

SCALE: 1:100

HORZ. 1:100

CONTRACT DRAWINGS CONTRACTOR MUST VERIFY ALL DIMENSIONS AND BE RESPONSIBLE FOR SAME. ANY DISCREPANCIES MUST BE REPORTED TO THE ENGINEER BEFORE COMMENCING WORK. DRAWINGS ARE NOT TO BE SCALED.

C.C. TATHAM & ASSOCIATES LTD. CLAIMS COPYRIGHT TO THIS DOCUMENT WHICH MAY NOT BE USED FOR ANY PURPOSE OTHER THAN THAT PROVIDED IN THE CONTRACT BETWEEN THE OWNER/CLIENT AND THE ENGINEER WITHOUT THE EXPRESS CONSENT OF C.C. TATHAM & ASSOCIATES LTD.

PIPE SIZES ARE IN MILLIMETRES UNLESS INDICATED. ELEVATIONS ARE IN METRES UNLESS INDICATED. ALL DIMENSIONS, ELEVATIONS AND SIZES ARE IN METRIC UNITS UNLESS INDICATED.

APPROVED FOR SUBMISSION



APPROVED FOR SUBMISSION





В

NO.



Tel (905) 688-6857 Fax (905) 688-6926 www.onelineeng.com





C.C. Tatham & Associates Ltd. **Consulting Engineers**


Bracebridge Orillia


NOT FOR CONSTRUCTION			NEXTERA ENERG	Y CANADA, ULC
			JERICHO WIND E	NERGY CENTRE
RESUBMITTED TO COUNTY FOR PERMITTING	12/05/13	K.P.	CABLE CF	ROSSING
INFORMATION FOR PERMITTING	06/11/13	K.P.	NORTHVILLE ROAD A	T CEDAR POINT LINE
REVISIONS	DATE	INITIAL	SCALE: AS NOTED	DATE: OCTOBER 2013


DWG. No. LC-094-CROSSING

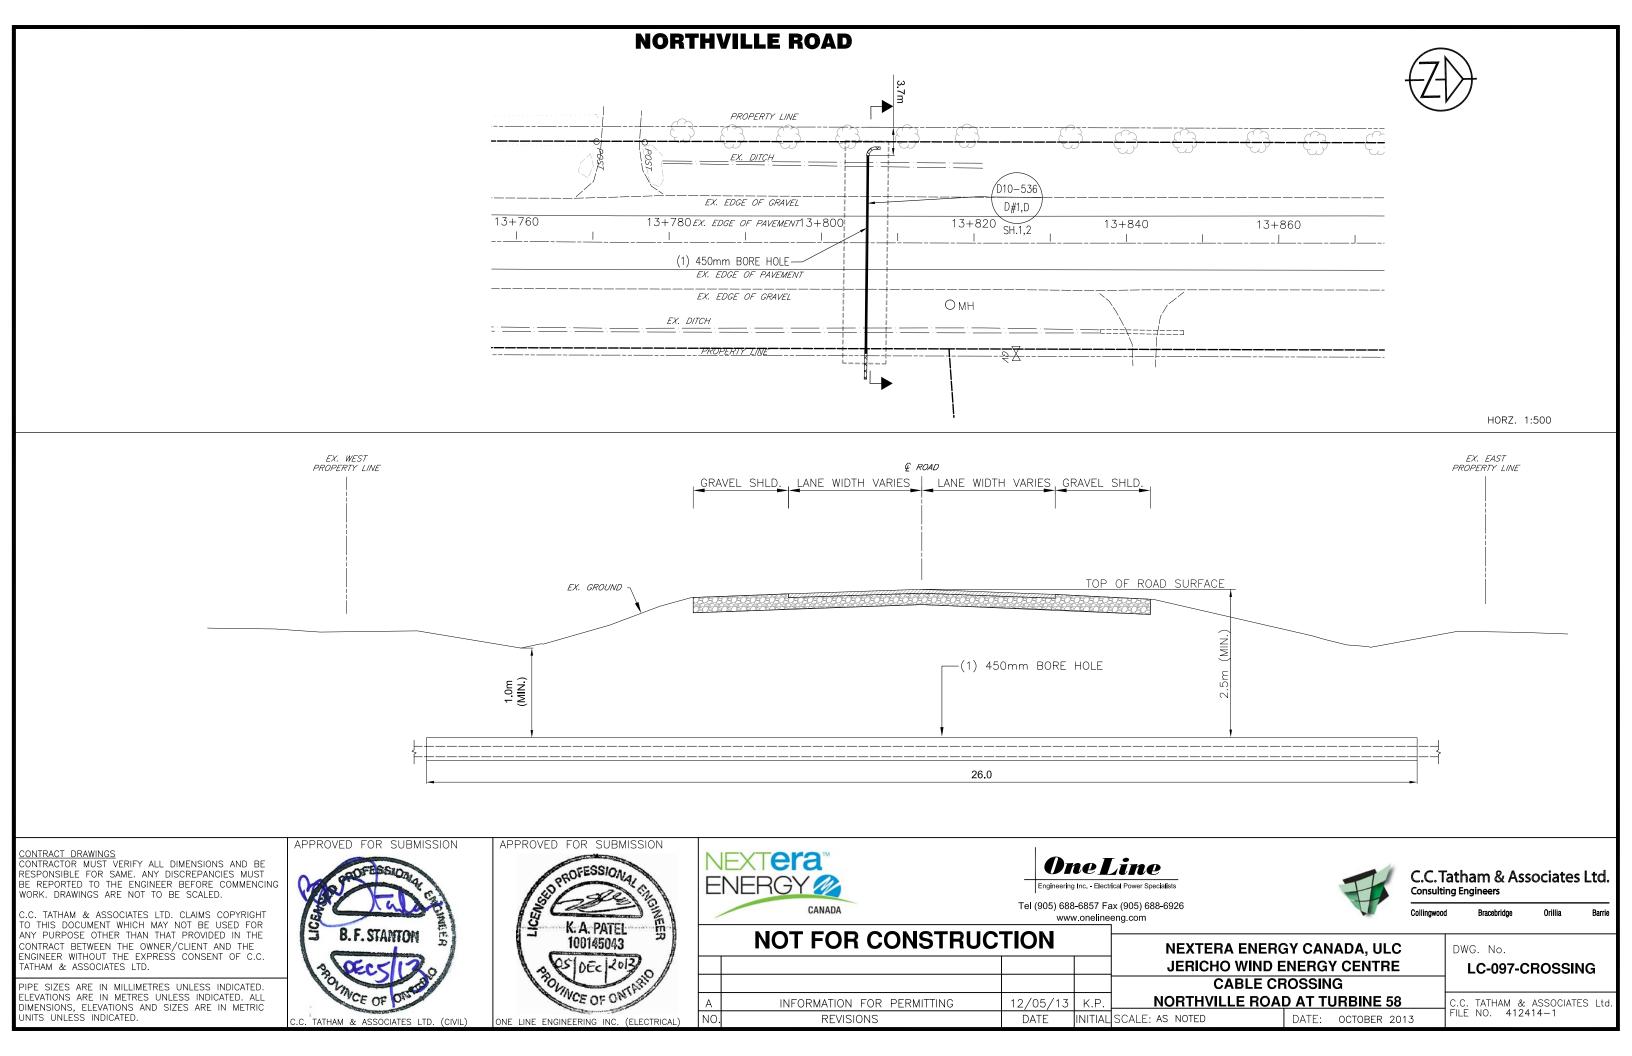


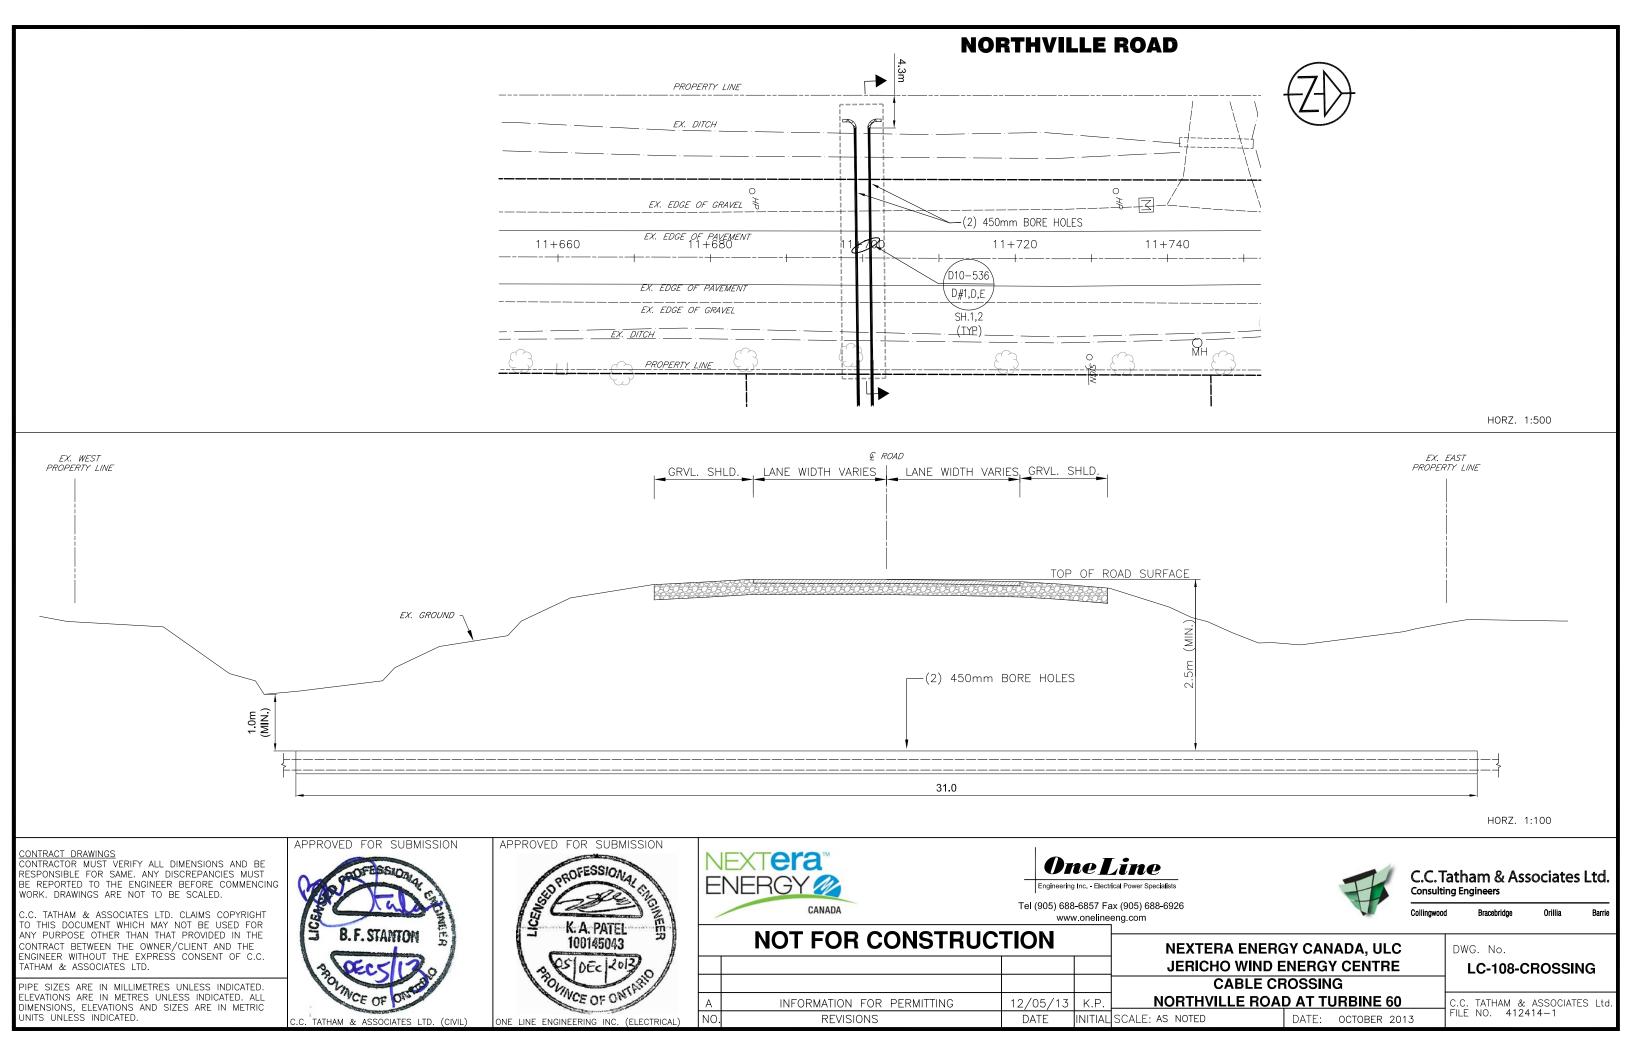


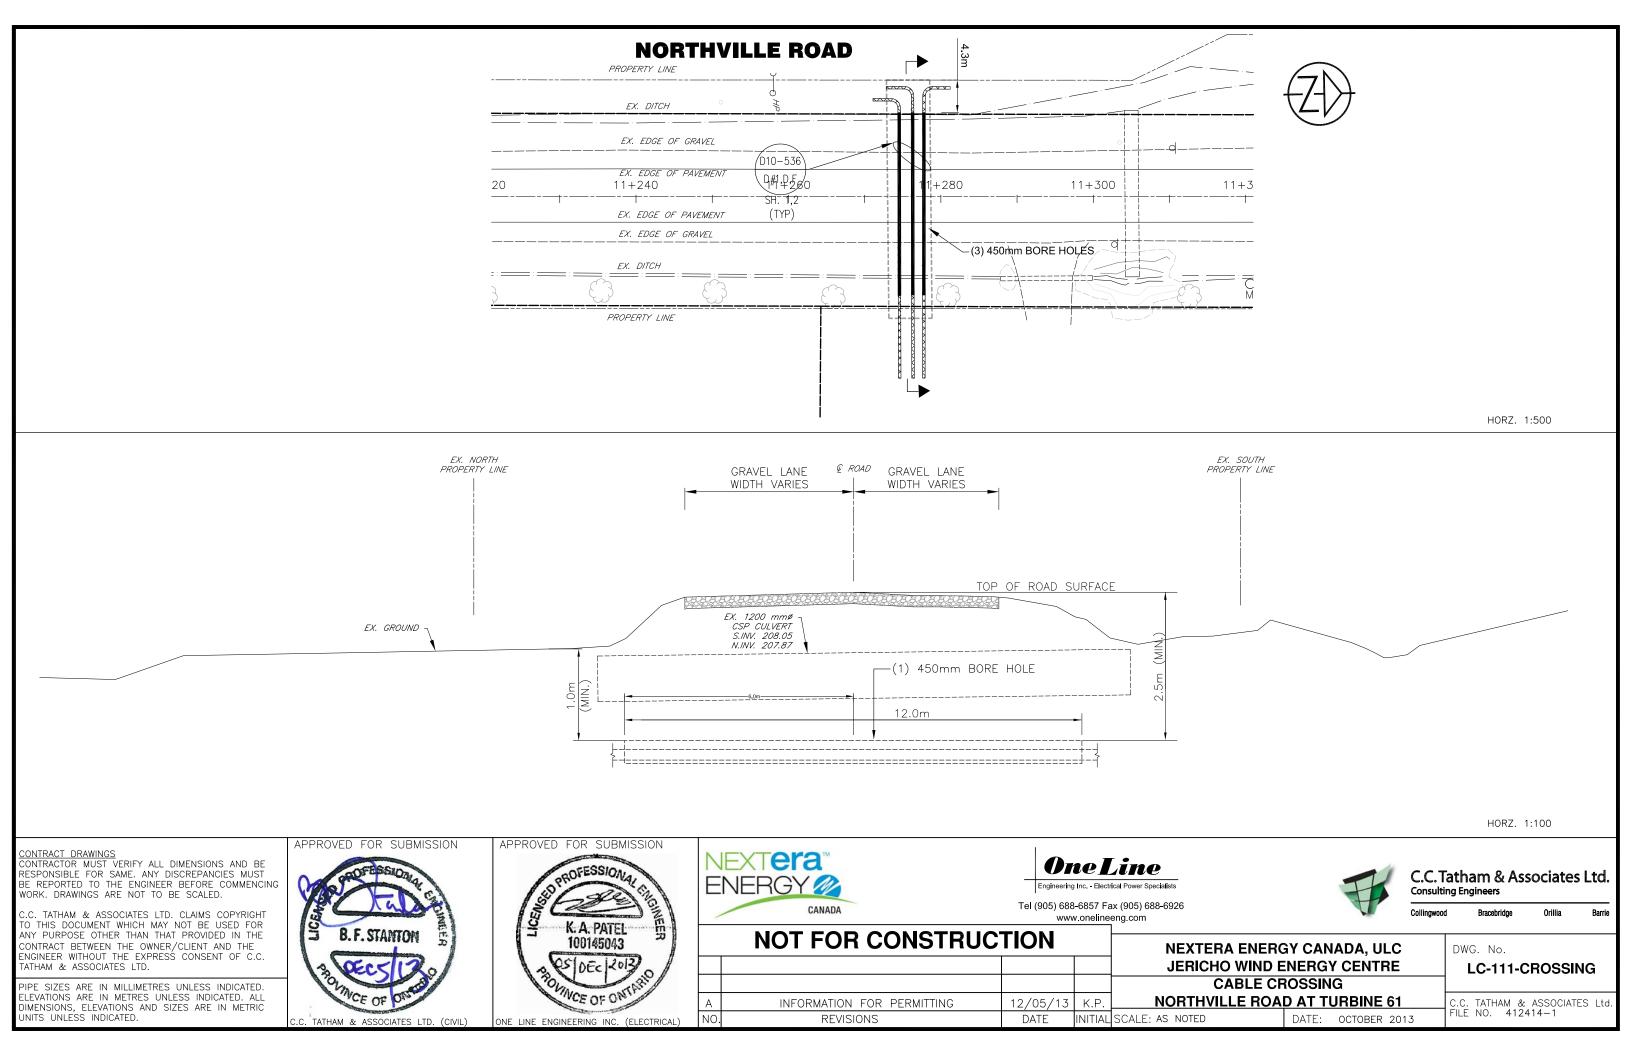


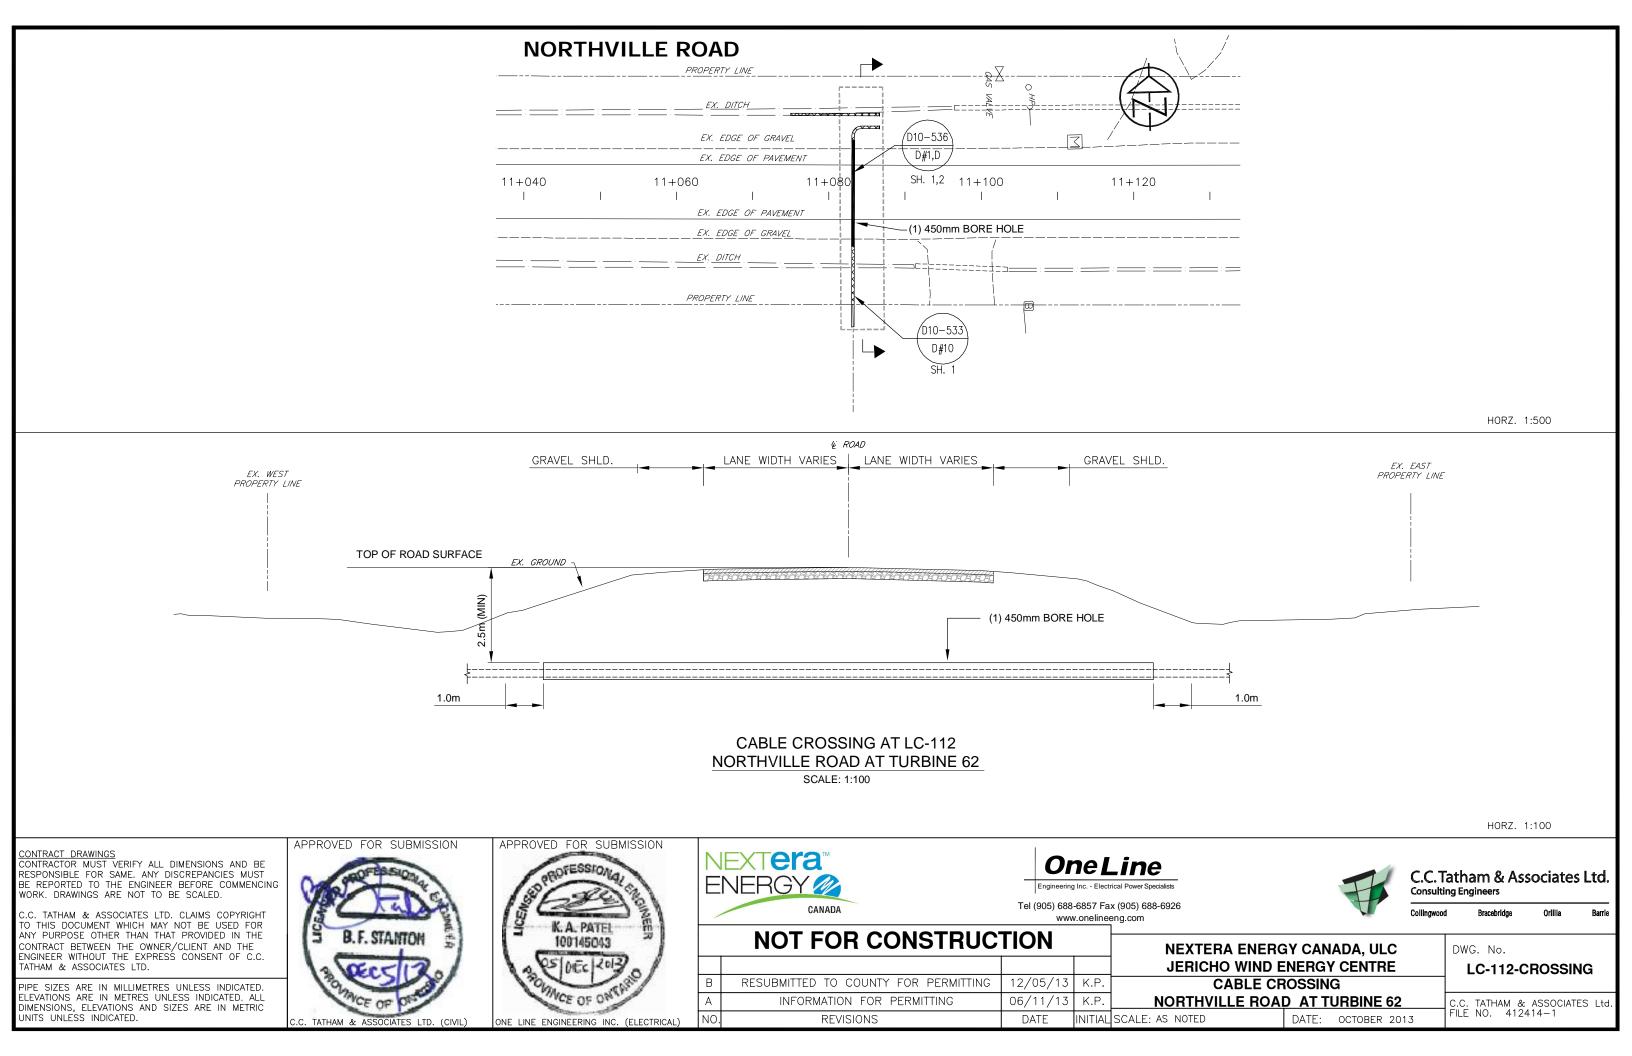

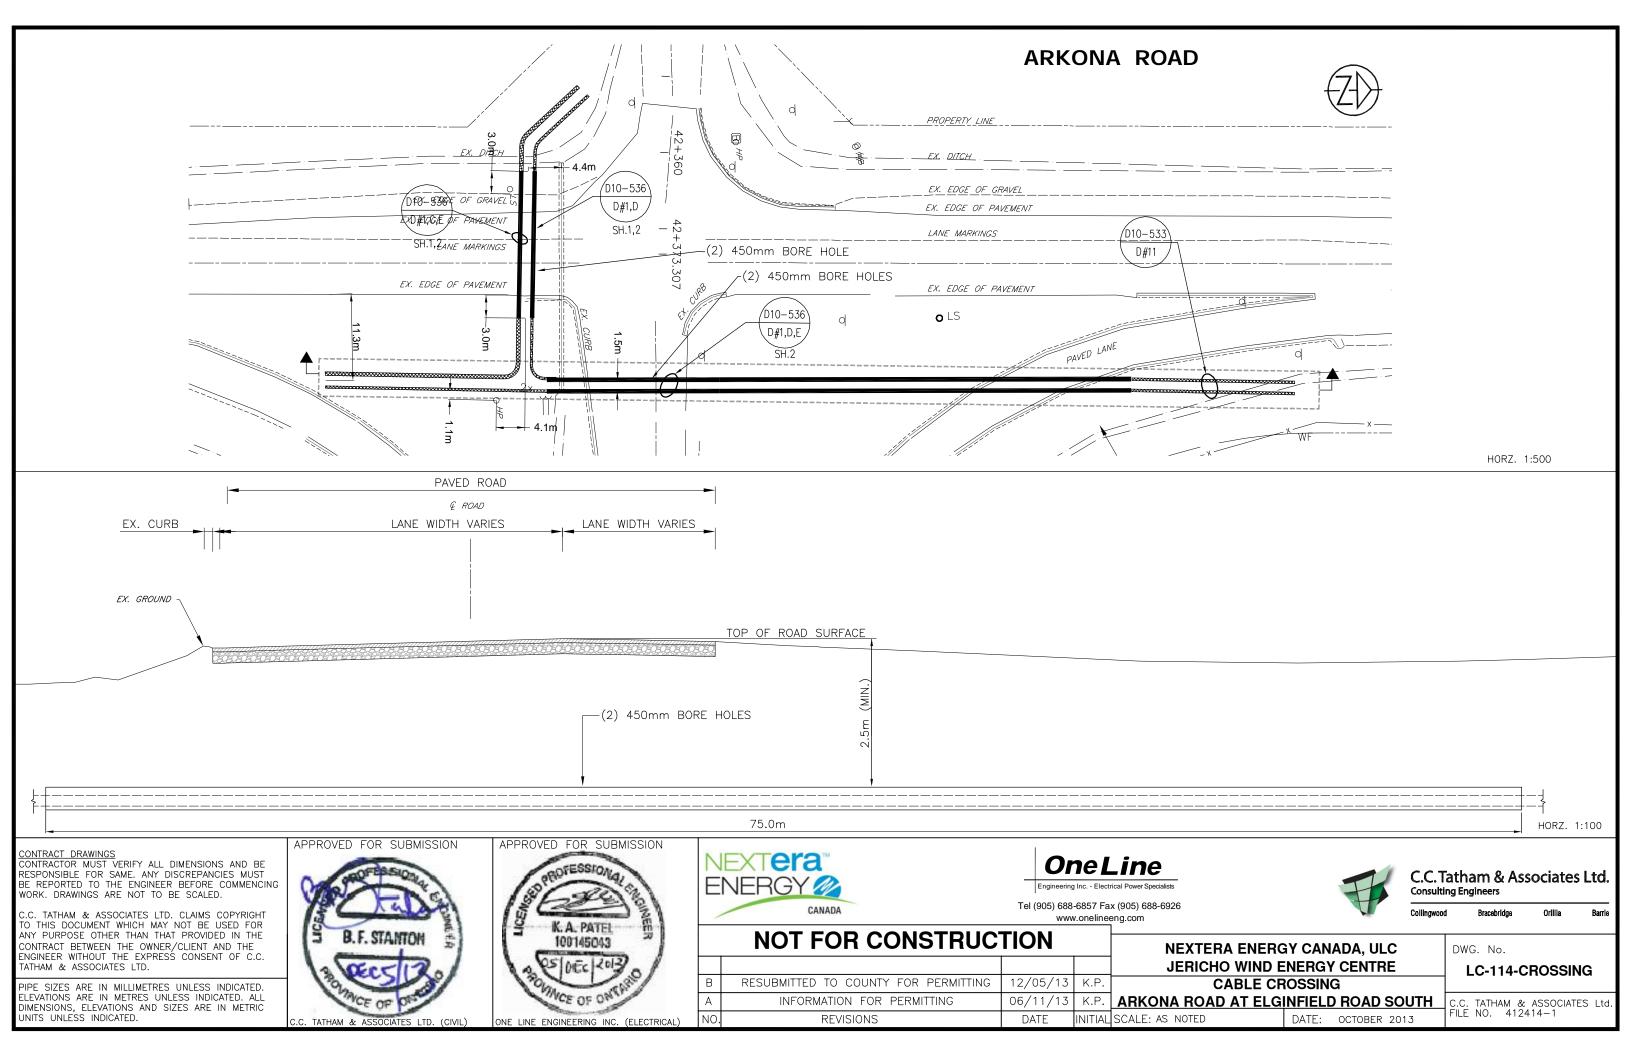

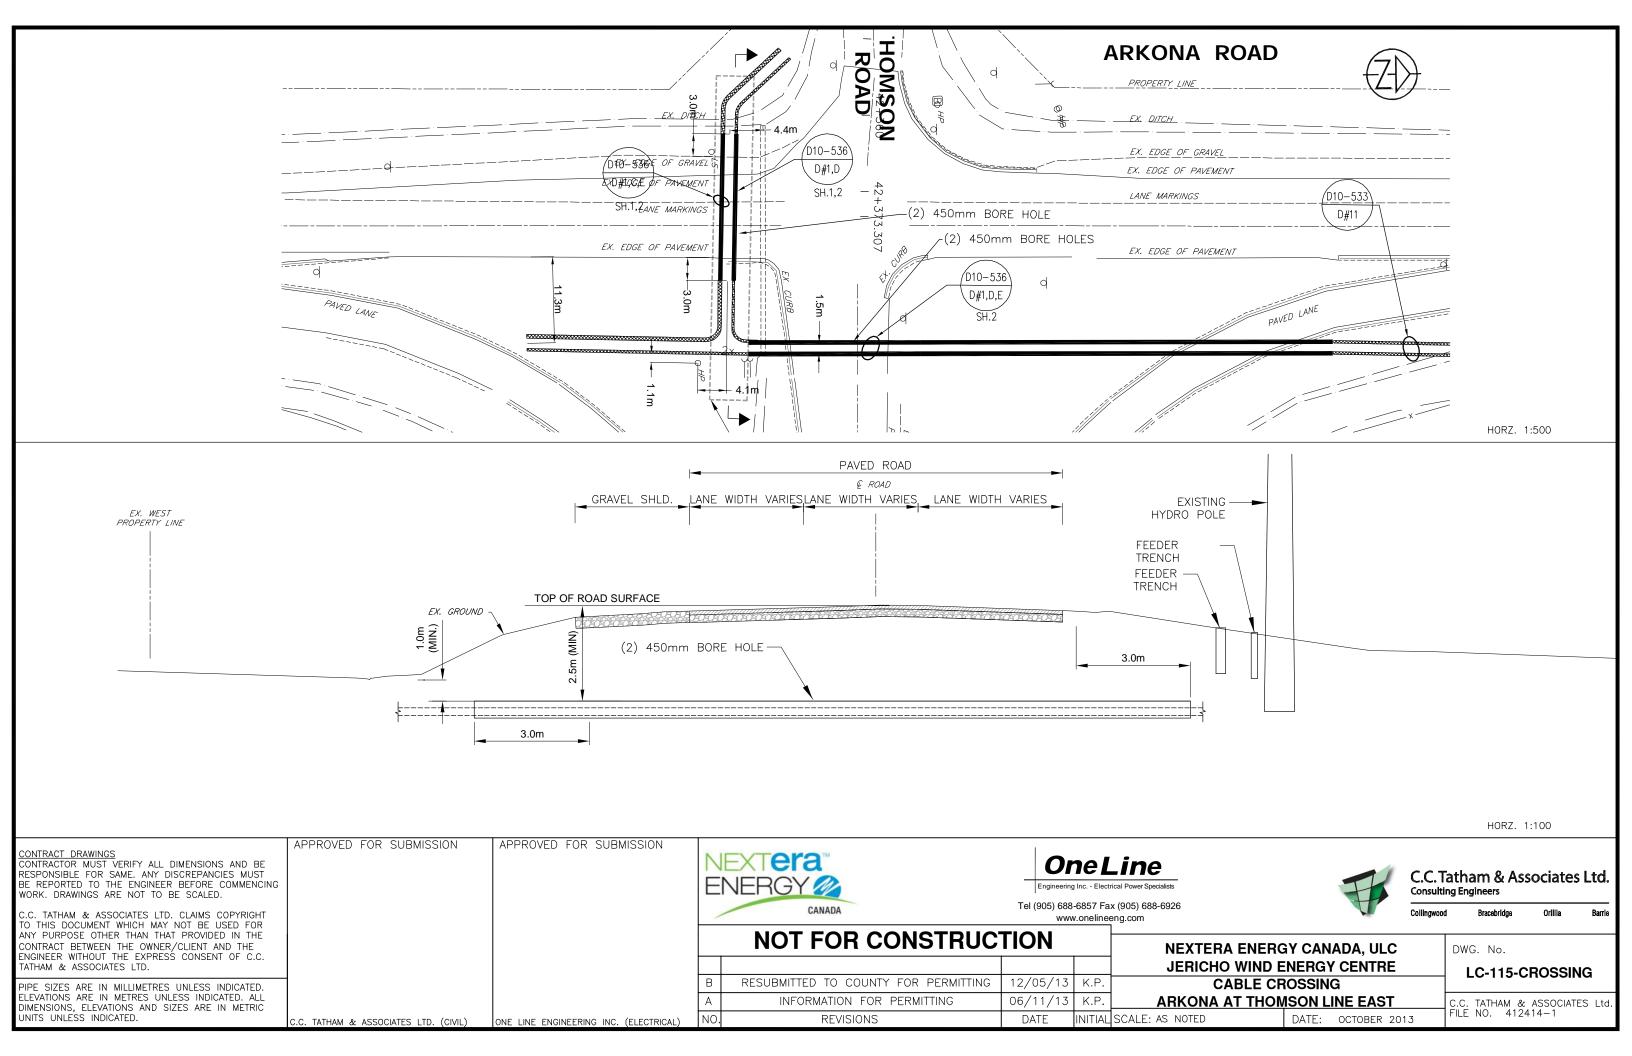


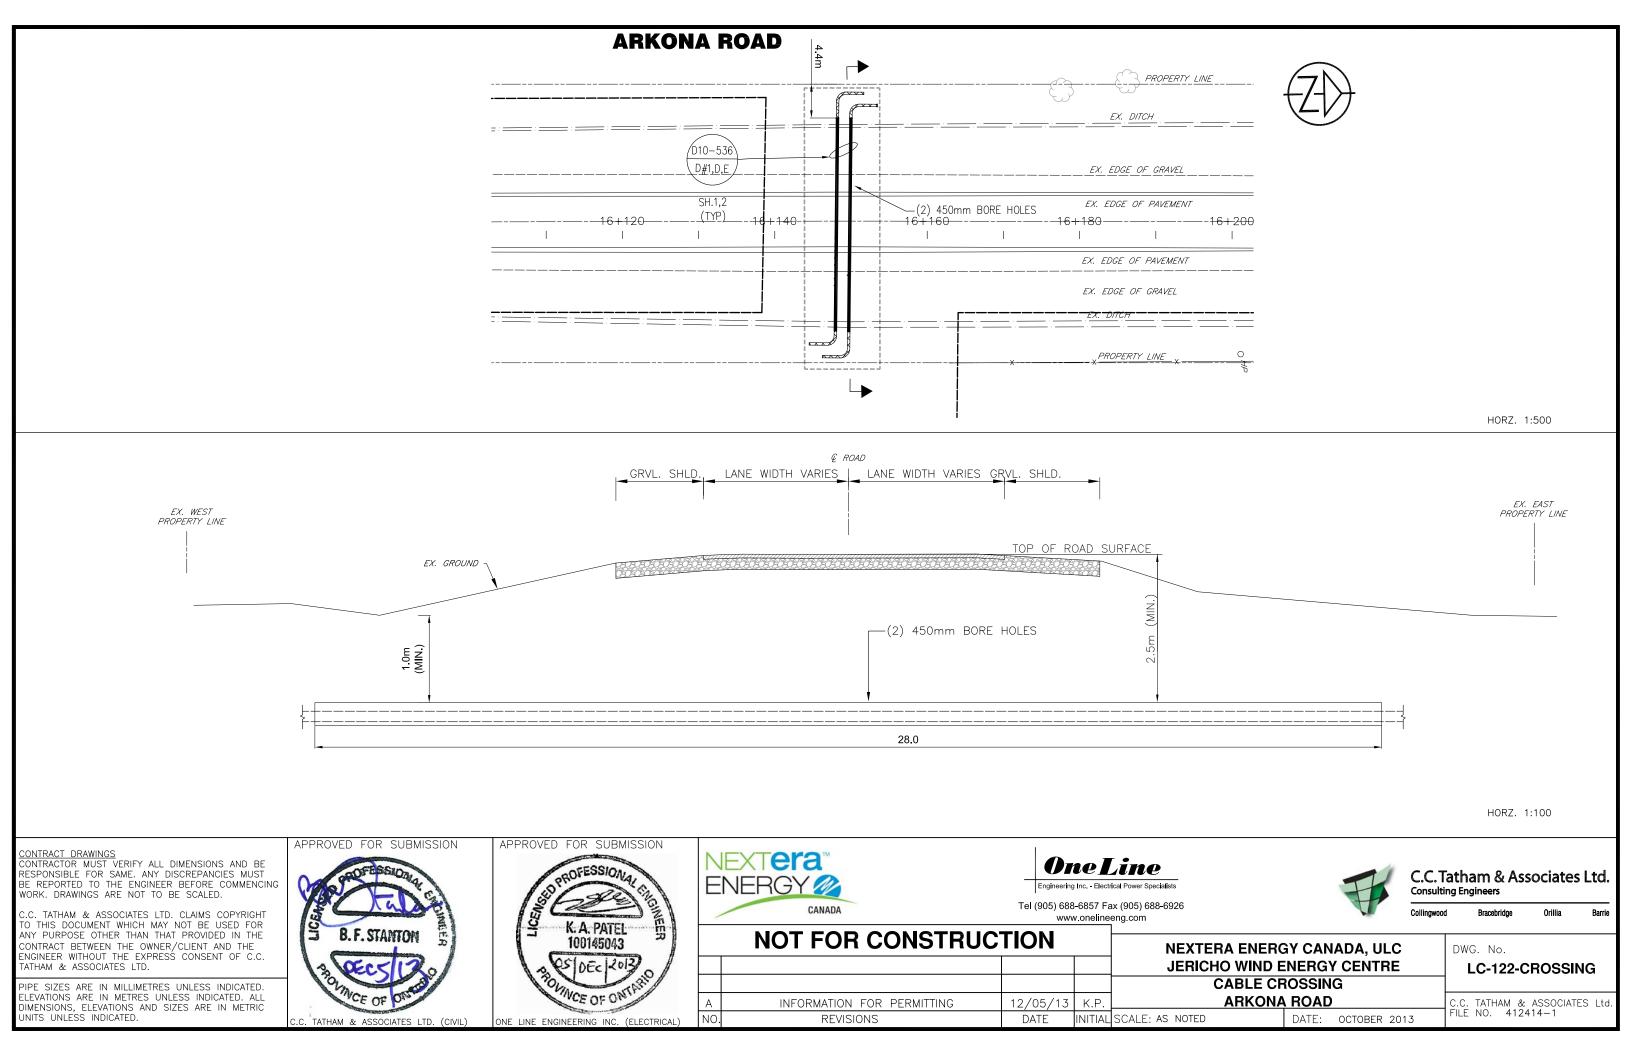


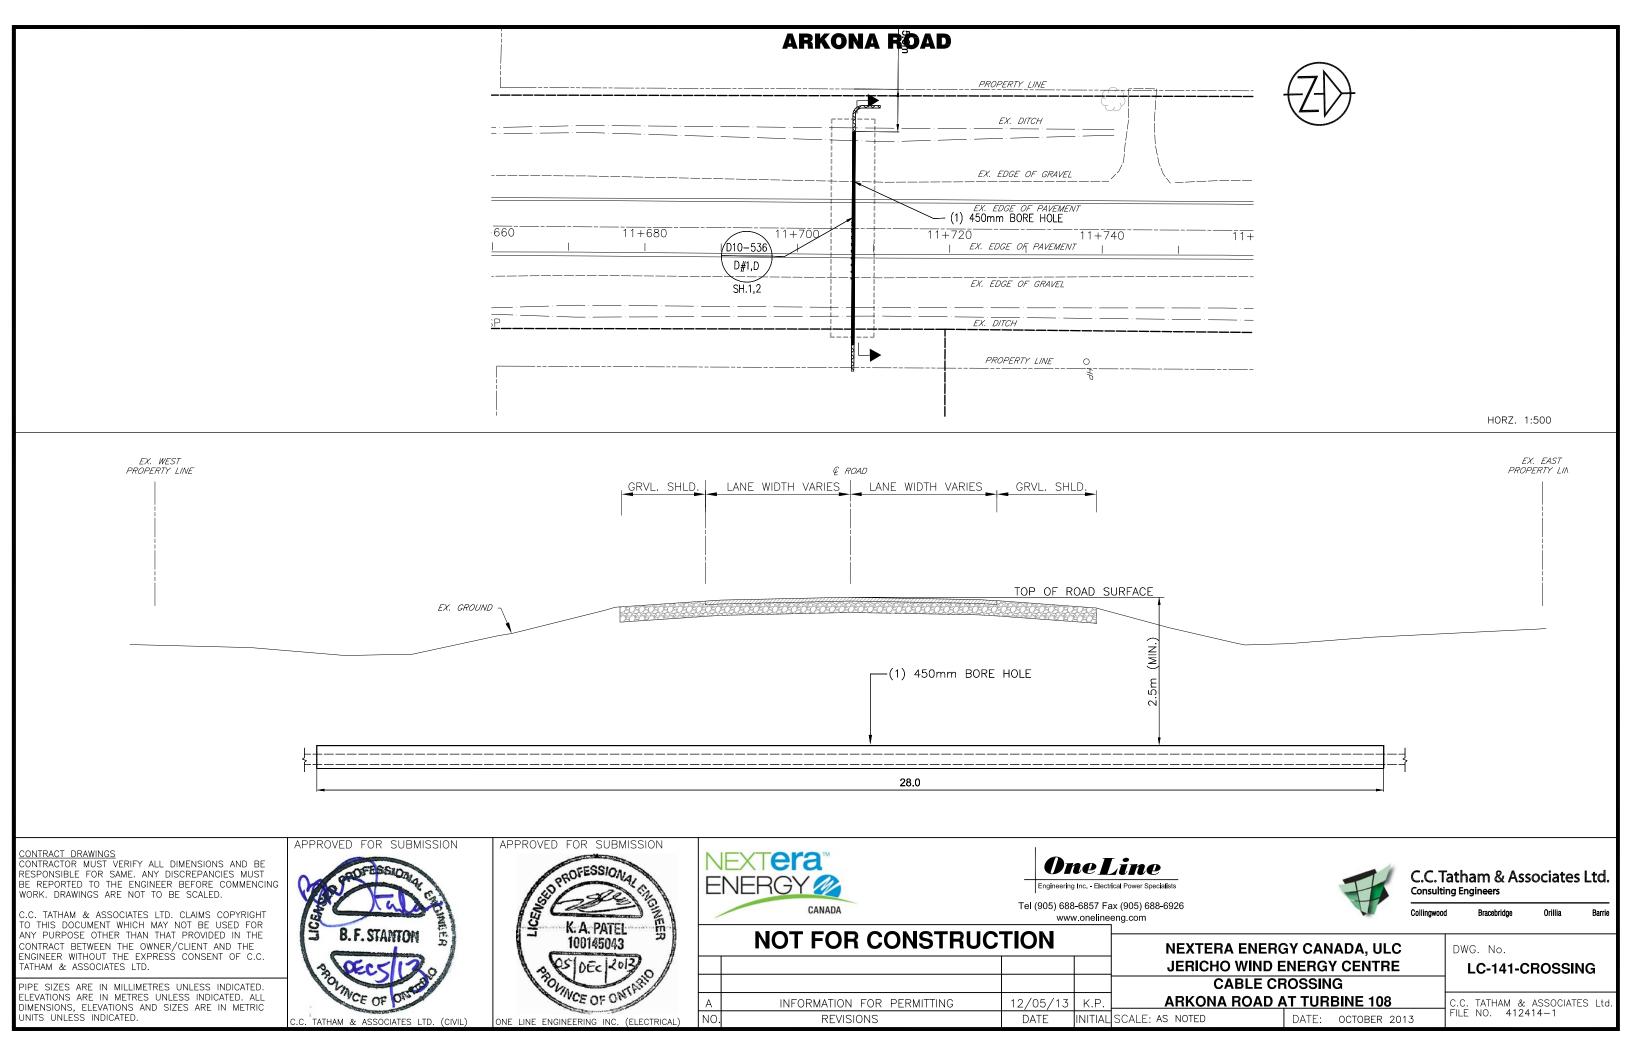



TOWNSEND LINE

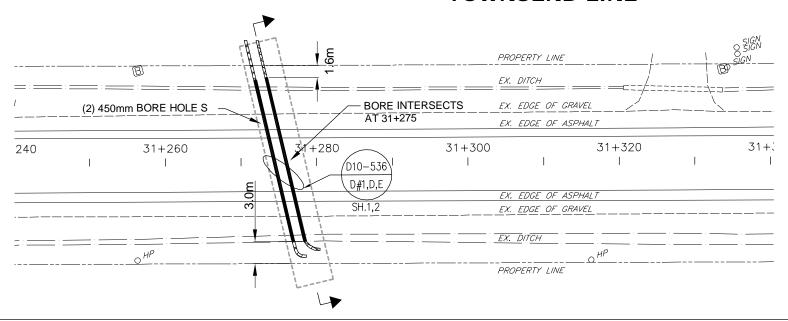

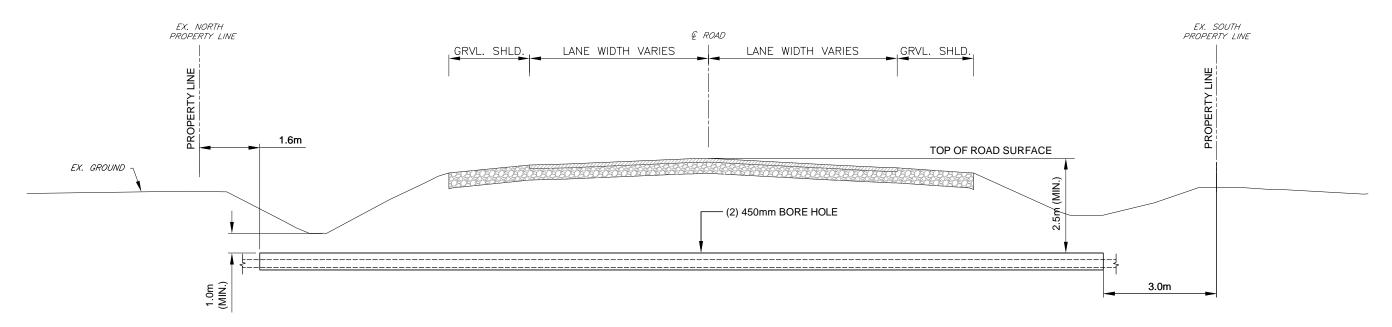

HORZ. 1:100


CONTRACT DRAWINGS

CONTRACTOR MUST VERIFY ALL DIMENSIONS AND BE RESPONSIBLE FOR SAME. ANY DISCREPANCIES MUST BE REPORTED TO THE ENGINEER BEFORE COMMENCING WORK. DRAWINGS ARE NOT TO BE SCALED.

C.C. TATHAM & ASSOCIATES LTD. CLAIMS COPYRIGHT TO THIS DOCUMENT WHICH MAY NOT BE USED FOR ANY PURPOSE OTHER THAN THAT PROVIDED IN THE CONTRACT BETWEEN THE OWNER/CLIENT AND THE ENGINEER WITHOUT THE EXPRESS CONSENT OF C.C. TATHAM & ASSOCIATES LTD.

PIPE SIZES ARE IN MILLIMETRES UNLESS INDICATED. ELEVATIONS ARE IN METRES UNLESS INDICATED. ALL DIMENSIONS, ELEVATIONS AND SIZES ARE IN METRIC JNITS UNLESS INDICATED.



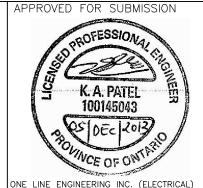



REVISIONS



Tel (905) 688-6857 Fax (905) 688-6926 www.onelineeng.com



DATE: OCTOBER 2013

C.C. Tatham & Associates Ltd. Consulting Engineers

Bracebridge Orillia


HORZ. 1:500


NEXTERA ENERGY CANADA, ULC	NOT FOR CONSTRUCTION		
JERICHO WIND ENERGY CENTRE			
CABLE CROSSING	K.P.	12/05/13	RESUBMITTED TO COUNTY FOR PERMITTING
TOWNSEND LINE AT TURBINE 38	K.P.	06/11/13	INFORMATION FOR PERMITTING


INITIAL SCALE: AS NOTED


DATE


DWG. No. LC-142-CROSSING

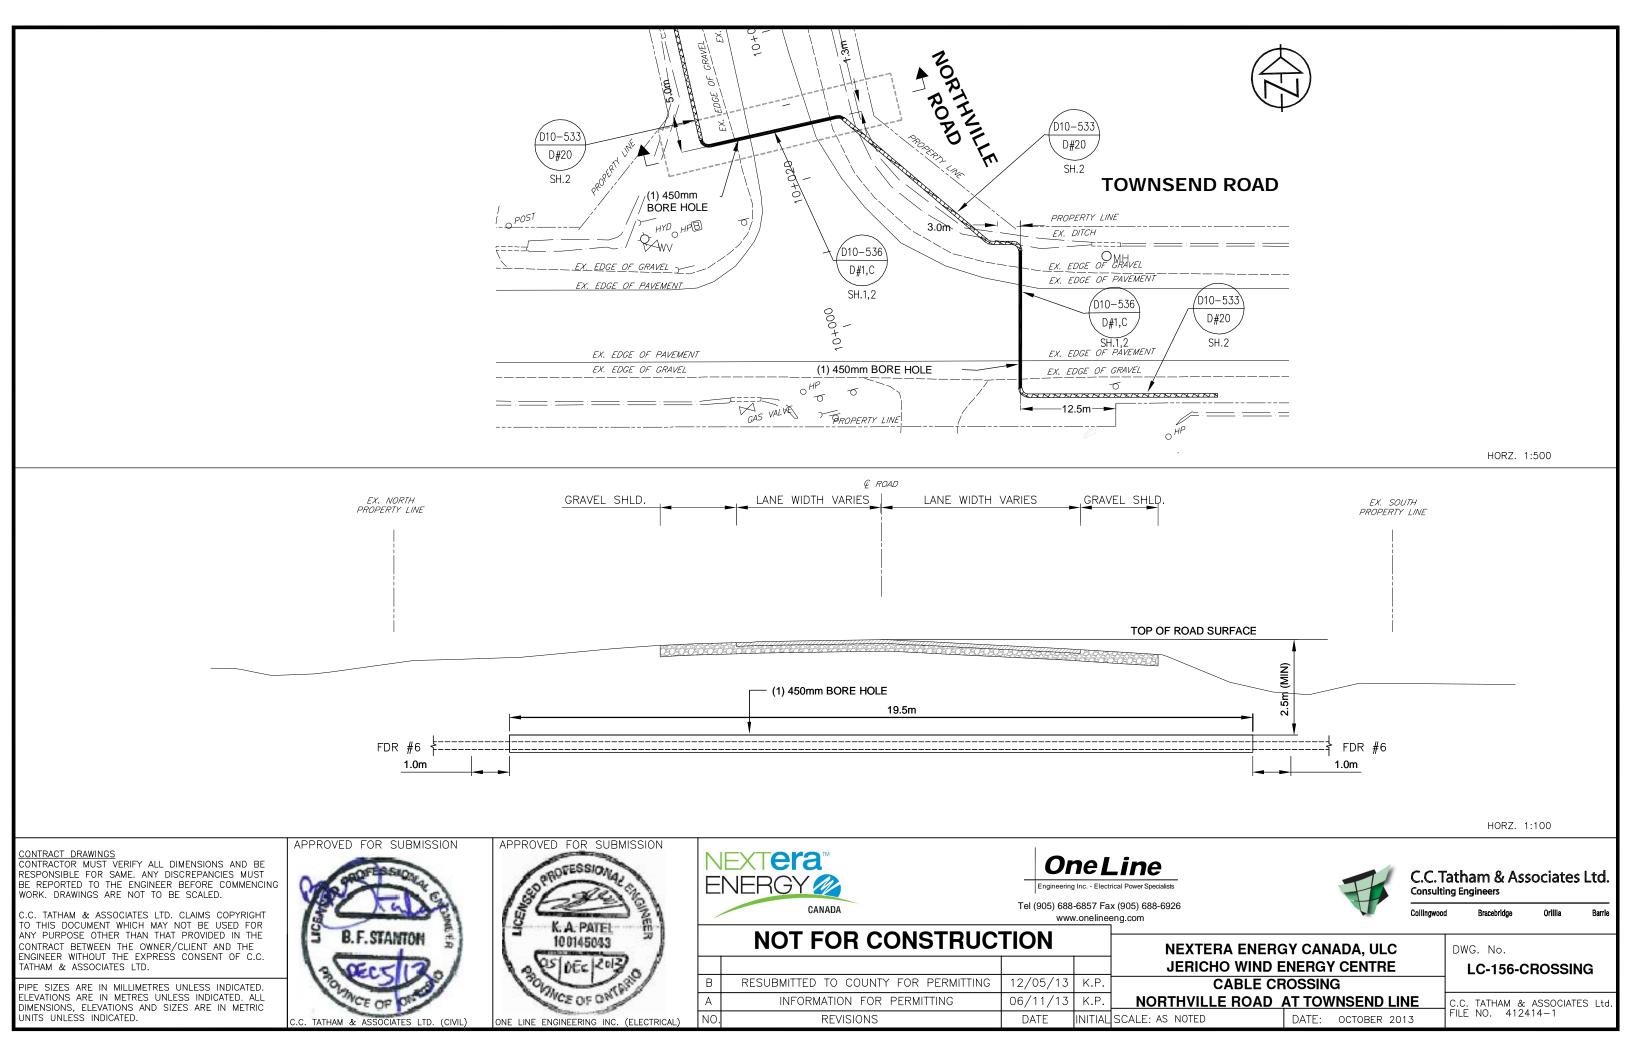

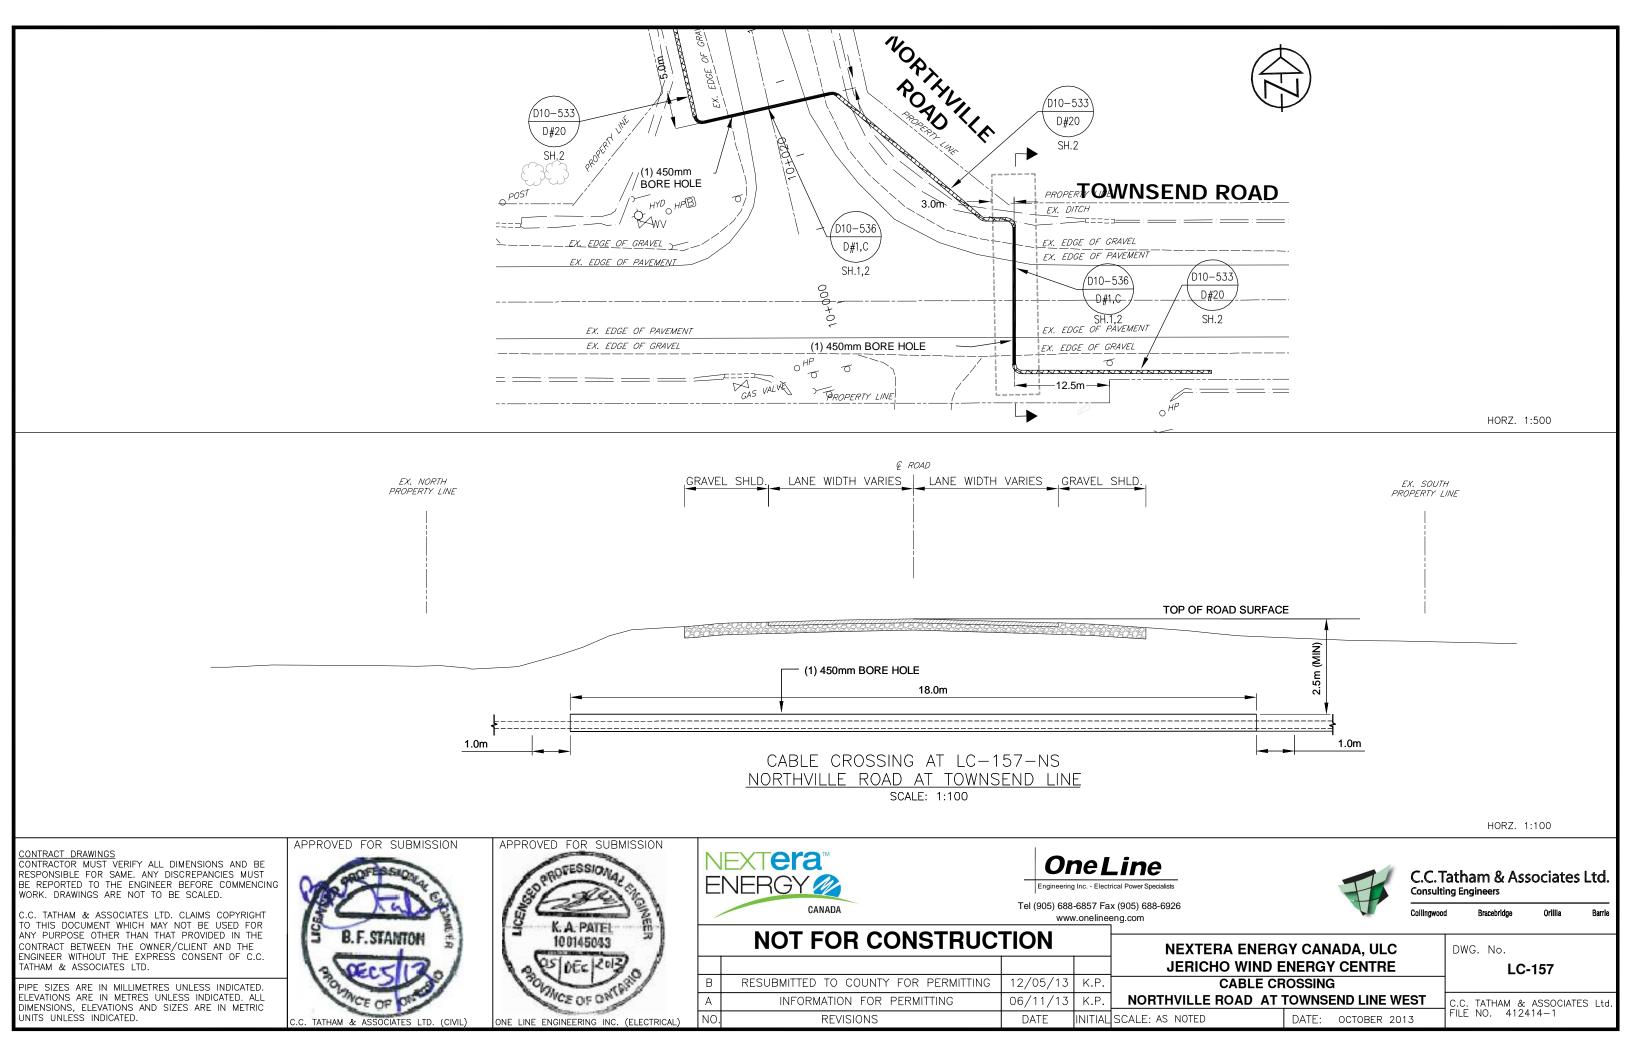

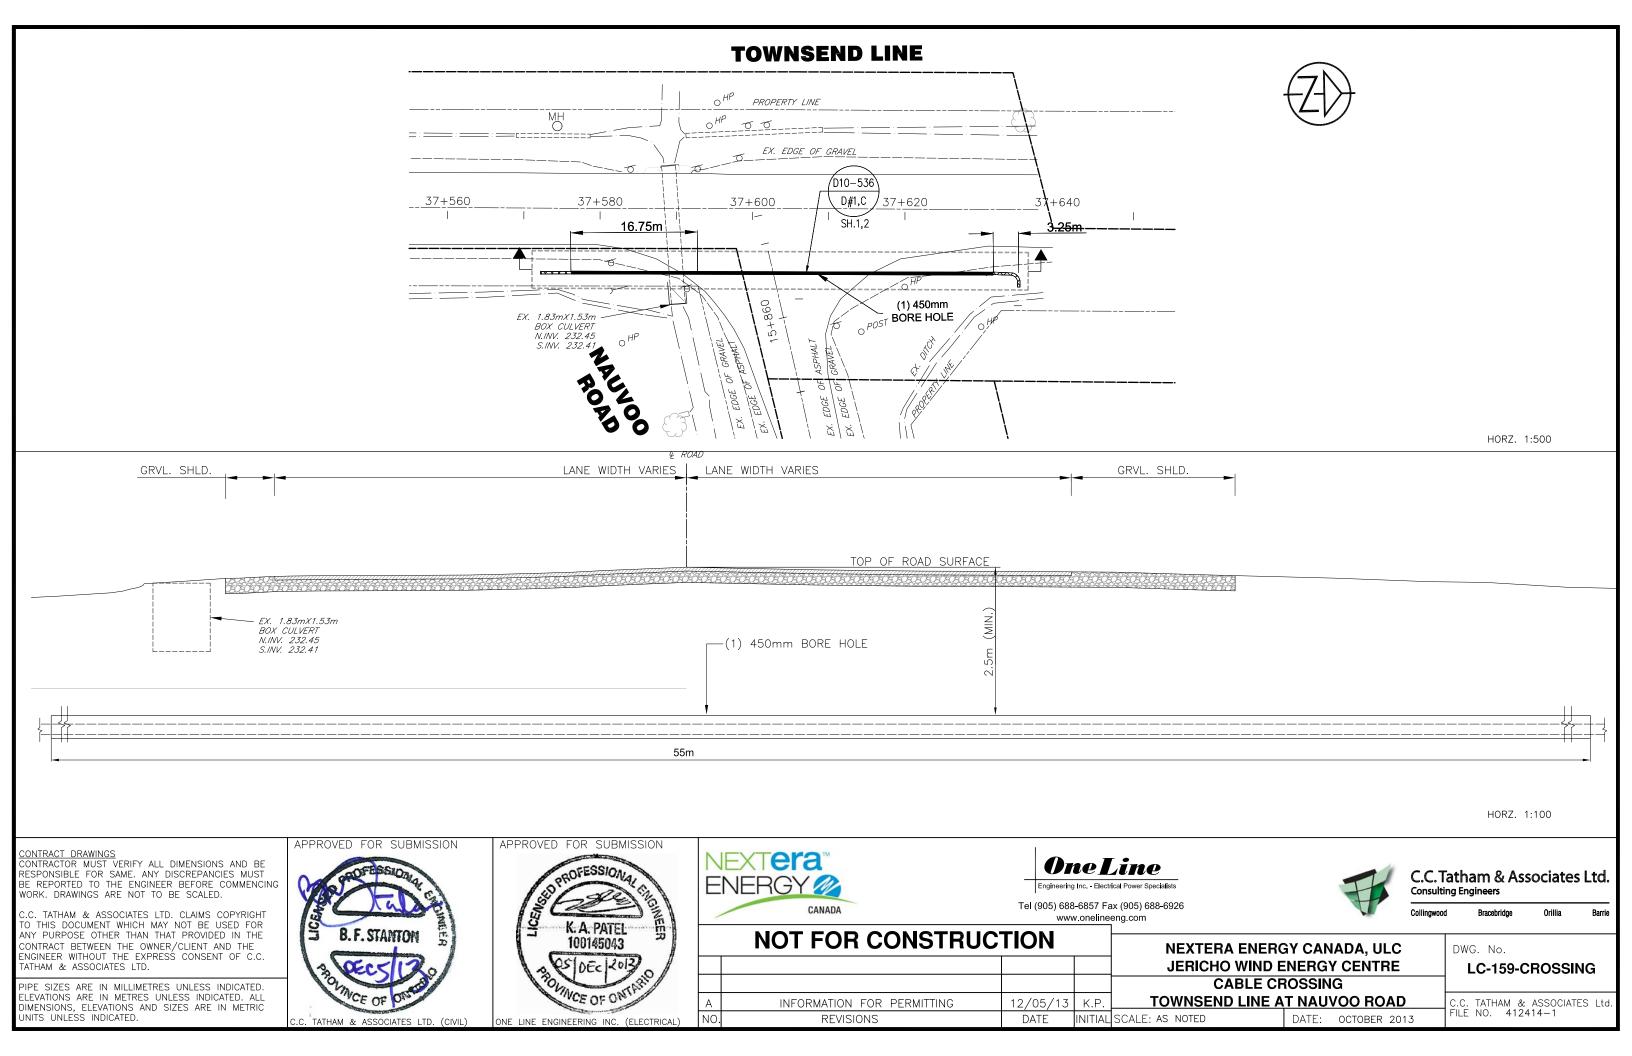

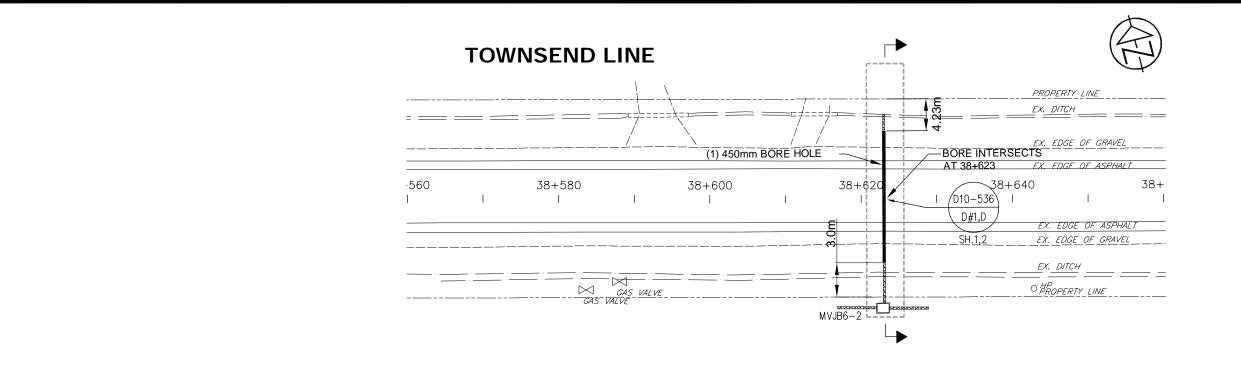

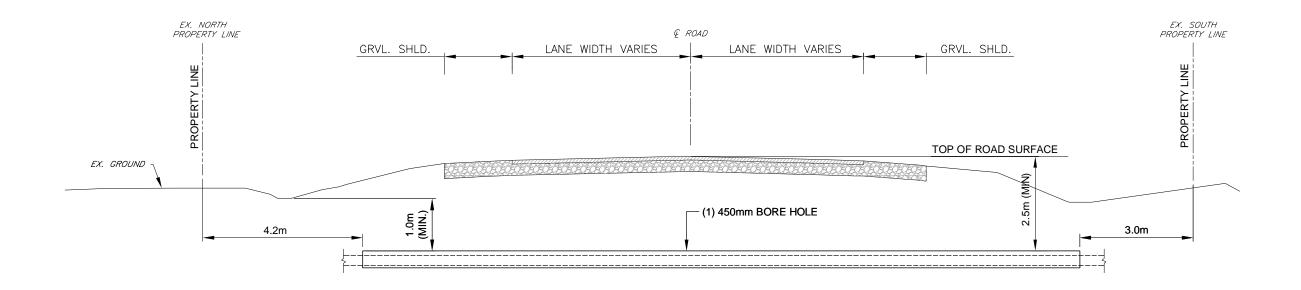


HORZ. 1:100 VERT. 1:50

CONTRACT DRAWINGS CONTRACTOR MUST VERIFY ALL DIMENSIONS AND BE RESPONSIBLE FOR SAME. ANY DISCREPANCIES MUST BE REPORTED TO THE ENGINEER BEFORE COMMENCING WORK. DRAWINGS ARE NOT TO BE SCALED.

C.C. TATHAM & ASSOCIATES LTD. CLAIMS COPYRIGHT TO THIS DOCUMENT WHICH MAY NOT BE USED FOR ANY PURPOSE OTHER THAN THAT PROVIDED IN THE CONTRACT BETWEEN THE OWNER/CLIENT AND THE ENGINEER WITHOUT THE EXPRESS CONSENT OF C.C. TATHAM & ASSOCIATES LTD.

PIPE SIZES ARE IN MILLIMETRES UNLESS INDICATED. ELEVATIONS ARE IN METRES UNLESS INDICATED. ALL DIMENSIONS, ELEVATIONS AND SIZES ARE IN METRIC INITS UNLESS INDICATED.



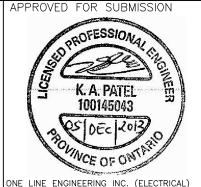



INFORMATION FOR PERMITTING

REVISIONS

One Line

Tel (905) 688-6857 Fax (905) 688-6926 www.onelineeng.com

K.P.

06/11/13

DATE




C.C. Tatham & Associates Ltd. **Consulting Engineers**


DWG. No.

Bracebridge

NOT FOR CONSTRUCTION NEXTERA ENERGY CANADA, ULC JERICHO WIND ENERGY CENTRE RESUBMITTED TO COUNTY FOR PERMITTING 12/05/13 **CABLE CROSSING**

TOWNSEND LINE AT TURBINE 63 & 64 INITIAL SCALE: AS NOTED DATE: OCTOBER 2013 LC-177-CROSSING

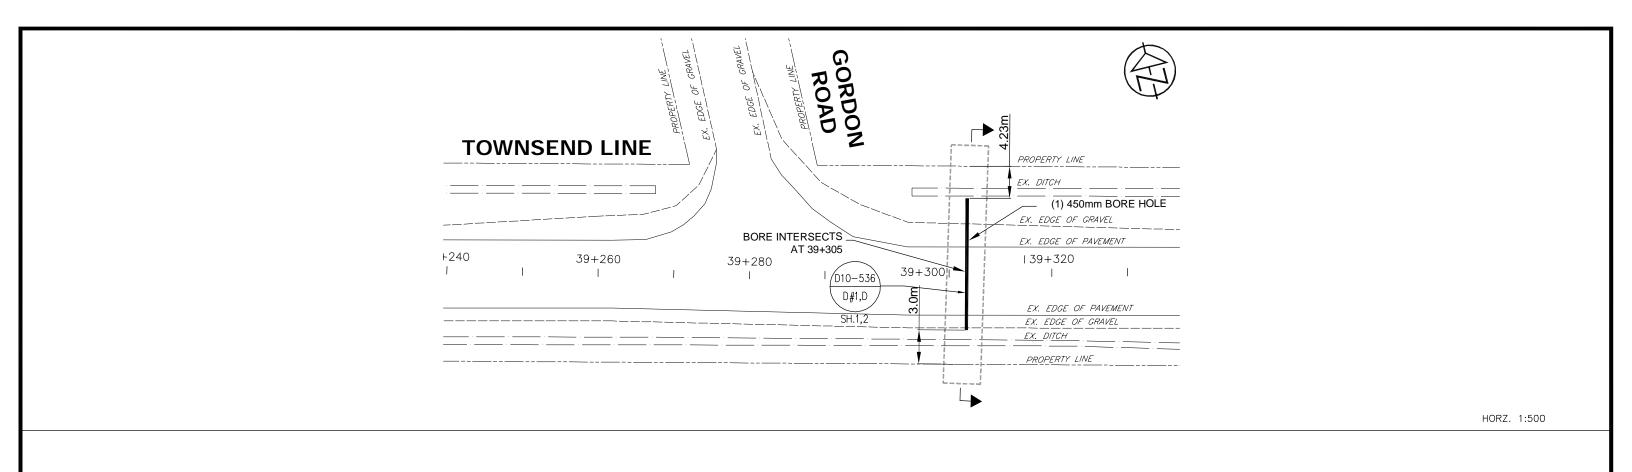

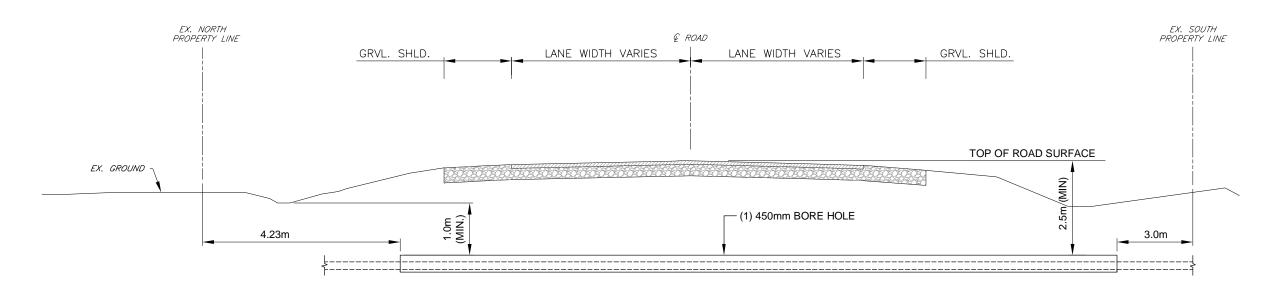

HORZ. 1:100 VERT. 1:50

CONTRACT DRAWINGS CONTRACTOR MUST VERIFY ALL DIMENSIONS AND BE RESPONSIBLE FOR SAME. ANY DISCREPANCIES MUST BE REPORTED TO THE ENGINEER BEFORE COMMENCING WORK. DRAWINGS ARE NOT TO BE SCALED.

C.C. TATHAM & ASSOCIATES LTD. CLAIMS COPYRIGHT TO THIS DOCUMENT WHICH MAY NOT BE USED FOR ANY PURPOSE OTHER THAN THAT PROVIDED IN THE CONTRACT BETWEEN THE OWNER/CLIENT AND THE ENGINEER WITHOUT THE EXPRESS CONSENT OF C.C. TATHAM & ASSOCIATES LTD.

PIPE SIZES ARE IN MILLIMETRES UNLESS INDICATED. ELEVATIONS ARE IN METRES UNLESS INDICATED. ALL DIMENSIONS, ELEVATIONS AND SIZES ARE IN METRIC UNITS UNLESS INDICATED.







RESUBMITTED TO COUNTY FOR PERMITTING

INFORMATION FOR PERMITTING

REVISIONS



Tel (905) 688-6857 Fax (905) 688-6926 www.onelineeng.com

12/05/13

06/11/13

DATE



NEXTERA ENERGY CANADA, ULC

JERICHO WIND ENERGY CENTRE

CABLE CROSSING

C.C. Tatham & Associates Ltd.
Consulting Engineers

D14/0 A1

DWG. No.


LC-180-CROSSING

K.P. TOWNSEND LINE AT GORDON ROAD
INITIAL SCALE: AS NOTED


DATE: OCTOBER 2013

C.C. TATHAM & ASSOCIATES Ltd. FILE NO. 412414-1

TOWNSEND LINE

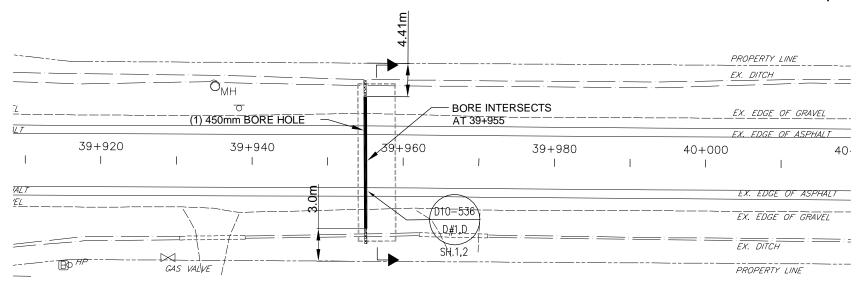

HORZ. 1:500

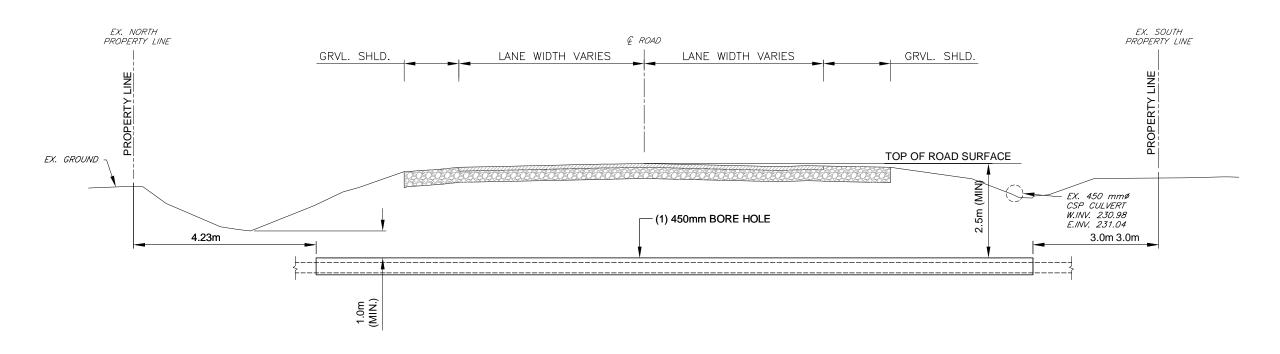

HORZ. 1:100 VERT. 1:50


CONTRACT DRAWINGS CONTRACTOR MUST VERIFY ALL DIMENSIONS AND BE

RESPONSIBLE FOR SAME. ANY DISCREPANCIES MUST BE REPORTED TO THE ENGINEER BEFORE COMMENCING WORK. DRAWINGS ARE NOT TO BE SCALED.

C.C. TATHAM & ASSOCIATES LTD. CLAIMS COPYRIGHT TO THIS DOCUMENT WHICH MAY NOT BE USED FOR ANY PURPOSE OTHER THAN THAT PROVIDED IN THE CONTRACT BETWEEN THE OWNER/CLIENT AND THE ENGINEER WITHOUT THE EXPRESS CONSENT OF C.C. TATHAM & ASSOCIATES LTD.

PIPE SIZES ARE IN MILLIMETRES UNLESS INDICATED. ELEVATIONS ARE IN METRES UNLESS INDICATED. ALL DIMENSIONS, ELEVATIONS AND SIZES ARE IN METRIC INITS UNLESS INDICATED.



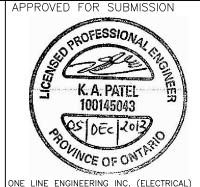



REVISIONS

NO.



Tel (905) 688-6857 Fax (905) 688-6926 www.onelineeng.com

DATE



DATE: OCTOBER 2013

C.C. Tatham & Associates Ltd. **Consulting Engineers**

DWG. No.

Bracebridge Orillia

NOT FOR CONSTRUCTION		NEXTERA ENERGY CANADA, ULC	
			JERICHO WIND ENERGY CENTRE
RESUBMITTED TO COUNTY FOR PERMITTING	12/05/13	K.P.	CABLE CROSSING
INFORMATION FOR PERMITTING	06/11/13	K.P.	TOWNSEND LINE AT TURBINE 94

INITIAL SCALE: AS NOTED

LC-184-CROSSING